NOTES

FIRE PROTECTION

ALL FIRE PROTECTION WORK SHALL BE PERFORMED IN ACCORDANCE WITH ALL APPLICABLE STANDARDS, RULES AND REGULATIONS OF THE NATIONAL FIRE PROTECTION ASSOCIATION (NFPA) AND ALL "AUTHORITIES HAVING JURISDICTION"

ALL MATERIALS AND EQUIPMENT TO BE USED IN THE INSTALLATION SHALL BE

"LISTED" FIRE PROTECTION MATERIALS AND EQUIPMENT ARE THOSE INCLUDED IN A LIST PUBLISHED BY AN ORGANIZATION ACCEPTABLE TO THE "AUTHORITIES HAVING JURISDICTION".

"AUTHORITIES HAVING JURISDICTION" ARE THE ORGANIZATIONS RESPONSIBLE FOR APPROVING EQUIPMENT, MATERIALS, INSTALLATION AND PROCEDURES. IN THIS PROJECT THE "AUTHORITIES HAVING JURISDICTION" ARE:

A- PUERTO RICO FIRE PROTECTION DEPARTMENT (SERVICIO DE BOMBEROS

- DE PUERTO RICO). B- INSURANCE COMPANY.
- C- DESIGNER

OTHER TYPES OF "LISTED" STEEL PIPE OR TUBE, JOINING AND FITTINGS MAY BE USED FOR THE SPRINKLER DISTRIBUTION. IF LIGHT WEIGHT (SCHEDULE 10) PIPE IS USED, ONLY ROLLED GROOVE FITTINGS ARE ALLOWED.

FIRE RISERS SHALL BE AS INDICATED IN DETAILS. ANY ADDITIONAL REQUIREMENTS OF THE "AUTHORITIES HAVING JURISDICTION" SHALL BE INCLUDED. SEE SPECIFICATION FOR MORE INFORMATION.

THE COMPLETE FIRE PROTECTION SYSTEM SHALL BE HYDRAULICALLY DESIGNED IN ACCORDANCE WITH THE FIRE PROTECTION SCHEDULE.

CONTRACTOR SHALL SUBMIT DETAILED SHOP DRAWINGS AND HYDRAULIC CALCULATIONS TO ARCHITECT / ENGINEER FOR APPROVAL PRIOR TO INSTALLATION SHOP DRAWING AND HYDRAULIC CALCULATIONS SUBMITTED SHALL BE SEALED & SIGNED BY A LICENSED ENGINEER IN THIS JURISDICTION.

THE CONTRACTOR SHALL COORDINATE WITH OWNER THE EXACT LOCATION OF FIRE EXTINGUISHERS. SEE FIRE EXTINGUISHER SCHEDULES FOR DETAILS.

ALL FIRE PROTECTION PIPING, INCLUDING FIRE RISER AND SPRINKLER PIPING SHALL BE PRIMED AND PAINTED RED.

MAXIMUM FLOOR AREA FOR EXTINGUISHERS 1250 SQ.FT.

CONTRACT SHALL PREPARE ACCURATE AS-BUILT OF ANY EXISTING FIRE PROTECTION DISTRIBUTION TO BE PART OF THE HYDRAULIC CALCULATIONS.

SEISMIC RESTRAINT

CONTRACTOR SHALL PROVIDE SEISMIC RESTRAINTS TO (BUT NOT BE LIMITED TO) THE FOLLOWING MECHANICAL ELEMENTS:

PUMPS

ALL EQUIPMENT, PIPING AND DUCTWORK SHALL BE RESTRAINED TO RESIST SEISMIC FORCES. RESTRAINTS SHALL MAINTAIN MECHANICAL EQUIPMENT, PIPING OR DUCT WORK IN A CAPTIVE POSITION. RESTRAINT DEVICES SHALL BE DESIGNED AND SELECTED TO MEET SEISMIC REQUIREMENTS AS DEFINED IN THE LATEST ISSUE OF UNIFORM BUILDING CODE. THIS SITE IS CLASSI-FIED AS SEISMIC ZONE 3. HOWEVER, THE MINIMUM HORIZONTAL RESTRAINT CAPABILITY SHALL BE 0.5g HORIZONTAL AND 0.33 VERTICAL. LIFE SAFETY EQUIPMENT SUCH AS SPRINKLER PIPING SHALL BE DESIGNED TO RESIST A MINIMUM 1.0g HORIZONTAL LOAD AND 0.67g VERTICAL LOAD. CONTRACTOR MUST PROVIDE SUBMITTALS FOR SEISMIC RESTRAINT. A SEISMIC DESIGN ERRORS AND OMISSIONS INSURANCE CERTIFICATE MUST ACCOMPANY SUBMITTALS FROM THE SEISMIC ENGINEER. MANUFACTURERS PRODUCT LIABILITY INSURANCE CERTIFI-CATES ARE NOT ACCEPTABLE. CONTRACTOR MUST PROVIDE SEISMIC CALCULA-TIONS, SIGNED BY A QUALIFIED LICENSED PROFESSIONAL ENGINEER SHOWING ADEQUACY SIZING AND TYPE.

GENERAL STRUCTURAL NOTES FOR MECHANICAL/ELECTRICAL COMPONENTS

- THE FOLLOWING NOTES APPLY TO ALL DRAWINGS, UNLESS OTHERWISE NOTED. (IF EXISTS, THE MOST STRINGENT BETWEEN THE STRUCTURAL DRAWINGS GENERAL NOTES/DETAILS AND THESE NOTES SHALL TAKE PRECEDENCE)
- BEFORE AND DURING CONSTRUCTION, THE CONTRACTOR SHALL CHECK THE ARCHITECTURAL, MECHANICAL, ELECTRICAL, EQUIPMENT AND ALL PROJECT RELATED DRAWINGS TO COORDINATE DIMENSIONS. PLACING OF SLEEVES, INSERTS, OPENINGS. ANCHORAGES, ETC.
- 3. THE CONTRACTOR SHALL VERIFY AND BE RESPONSIBLE FOR ALL DIMENSIONS AND CONDITIONS AT THE SITE AND SHALL NOTIFY THE MECHANICAL ENGINEER OF DISCREPANCIES BETWEEN THE ACTUAL CONDITIONS AND INFORMATION SHOWN ON THE DRAWINGS BEFORE PROCEEDING WITH THE WORK.
- . THE CONTRACTOR SHALL IMMEDIATELY NOTIFY THE MECHANICAL/STRUCTURAL ENGINEER OR OWNERS REPRESENTATIVE OF ANY CONDITION WHICH, IN HIS/HER OPINION, MIGHT ENDANGER THE STABILITY OF THE EQUIPMENT OR SUPPORTING STRUCTURE OR CAUSE ANY DISTRESS.
- SPECIFIC NOTES & DETAILS SHALL TAKE PRECEDENCE OVER THESE NOTES & TYPICAL DETAILS.
- 6. THE CONTRACTOR SHALL REFER TO THE SPECIFICATIONS FOR INFORMATION NOT COVERED BY THE NOTES OR THE DRAWINGS.
- THE CONTRACTOR SHALL PROVIDE TEMPORARY ERECTION BRACING & SHORING FOR ALL EQUIPMENTS AND COMPONENTS OR AS REQUIRED FOR THEIR STRUCTURAL STABILITY DURING ALL PHASES OF CONSTRUCTION.
- 8. NOT ALL NOTES INCLUDED HEREIN ARE PART OF THE ORIGINAL SCOPE OF WORK BUT SHALL BE USED IN THE EVENT OF CHANGES OF ANY ADDITIONAL WORK REQUIRED.

REFERENCES:

THE FOLLOWING DOCUMENTS, THEIR COMMENTARIES AND THE STANDARDS REFERENCED THEREIN, SHALL APPLY TO DESIGN, FABRICATION AND CONSTRUCTION PRACTICES TO BE ADHERED TO WITH TO WITH REGARD TO THE WORK SHOWN ON THE DRAWINGS: (IF EXISTS, STRUCTURAL DRAWINGS SHALL TAKE PRECEDENCE)

A) STRUCTURAL STEEL

- 1) AISC MANUAL OF STEEL CONSTRUCTION
- 2) AISC MANUAL OF STEEL CONSTRUCTION, VOL. II CONNECTIONS
- 3) AWS STRUCTURAL WELDING CODE
- B) CODES AND DESIGN STANDARDS FOR CONCRETE COMPONENTS
- 1) STANDARD SPECIFICATIONS FOR STRUCTURAL CONCRETE, (ACI 301-05).
- 2) BUILDING CODE REQUIREMENTS FOR STRUCTURAL CONCRETE
- (ACI 318-08) AND COMMENTARY (ACI 318R-08).
- 3) 2018 PUERTO RICO BUILDING CODE, PRBC 2018
- 4) 2018 INTERNATIONAL BUILDING CODE, IBC 2018
- 5) MINIMUN DESIGN LOADS FOR BUILDINGS AND OTHER STRUCTURES (ASCE 7-05)

MATERIALS:

. THE FOLLOWING SPECIFICATIONS APPLY TO THE STRUCTURAL STEEL WORK:

A) STEEL SHAPES ASTM A992/572, FY=50 KS B) STEEL PLATES, ANGLES AND BARS. ASTM A-36

C) TUBULAR SECTIONS, GRADE B ASTM A-500

ASTM A-53 TYPE E OR S D) STEEL PIPE - FOR STRUCTURAL USE ONLY

E) HIGH STRENGTH BOLTS ASTM A-325

ASTM A36 G) THREADED RODS

EXPOSED TO WEATHER SHALL BE HOT DIP GALVANIZED

H) ANCHOR RODS

ASTM A-449 WELD FILLER MATERIAL, E70XX ELECTRODES

J) EXPANSION ANCHORS KWIK BOLT 3 BY HILTI ZINC COATED OR SS AS REQ'D)


FOR MASONRY - HIT HY20 SYSTEM

K) EPOXY FOR EMBEDMENT FOR CONCRETE - HVA ADHESIVE SYSTEM FIRE PROTECTION PIPING SCHEDULE

SPECIFICATION	SERVICE	MATERIAL	SCHEDULE	CLASS OR TYPE	SPECIFICATION	COATING OR LINING		JOINT & FITTINGS		
						TYPE	SPECIFICATION	TYPE	JT. MAT.	SPECIFICATION
	FIRE DISTRIBUTION PIPE AND STAND PIPE ABOVE GRADE LARGER THAN 3"	CARBON STEEL	40	1	ASTM A-53	HIGH PERFORMANCE	ASTM A-120	MECHANICAL COUPLING	CARBON STEEL	ASTM A-234 WPB ANSI B 16.9

PIPE SHALL BE PAINTED RED. IN CASE THE PIPE IS EXPOSED TO VIEW REFER TO ARCHITECTURAL DRAWINGS FOR FINAL COLOR OF PIPE.

	SPRIN	NKLER LEGEND			
LEGEND	DESCRIPTION	SIMILAR TO			
•	PENDENT SPRINKLER FOR LIGHT AND ORDINARY GROUP 1 HAZARDS AREAS	RELIABLE MODEL F156 STANDARD RESPONESE PENDENT SPRINKLER HEAD. K-FACTOR 5.6,			

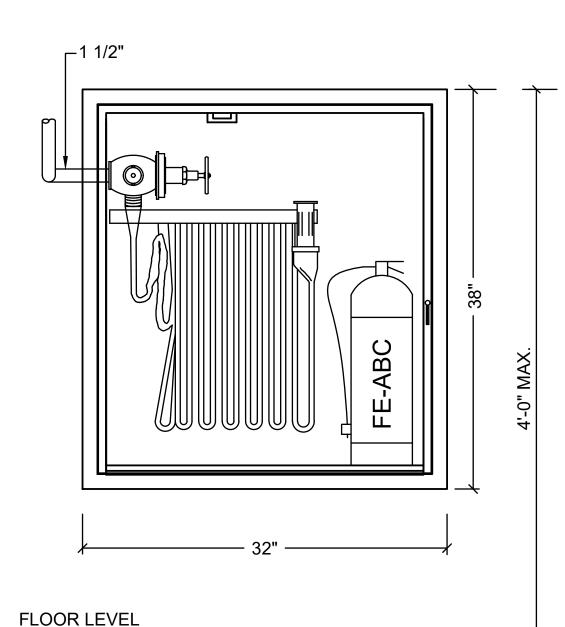

FIRE HOSE CABINET FHC-A

MOUNTING DETAIL

FP1-00



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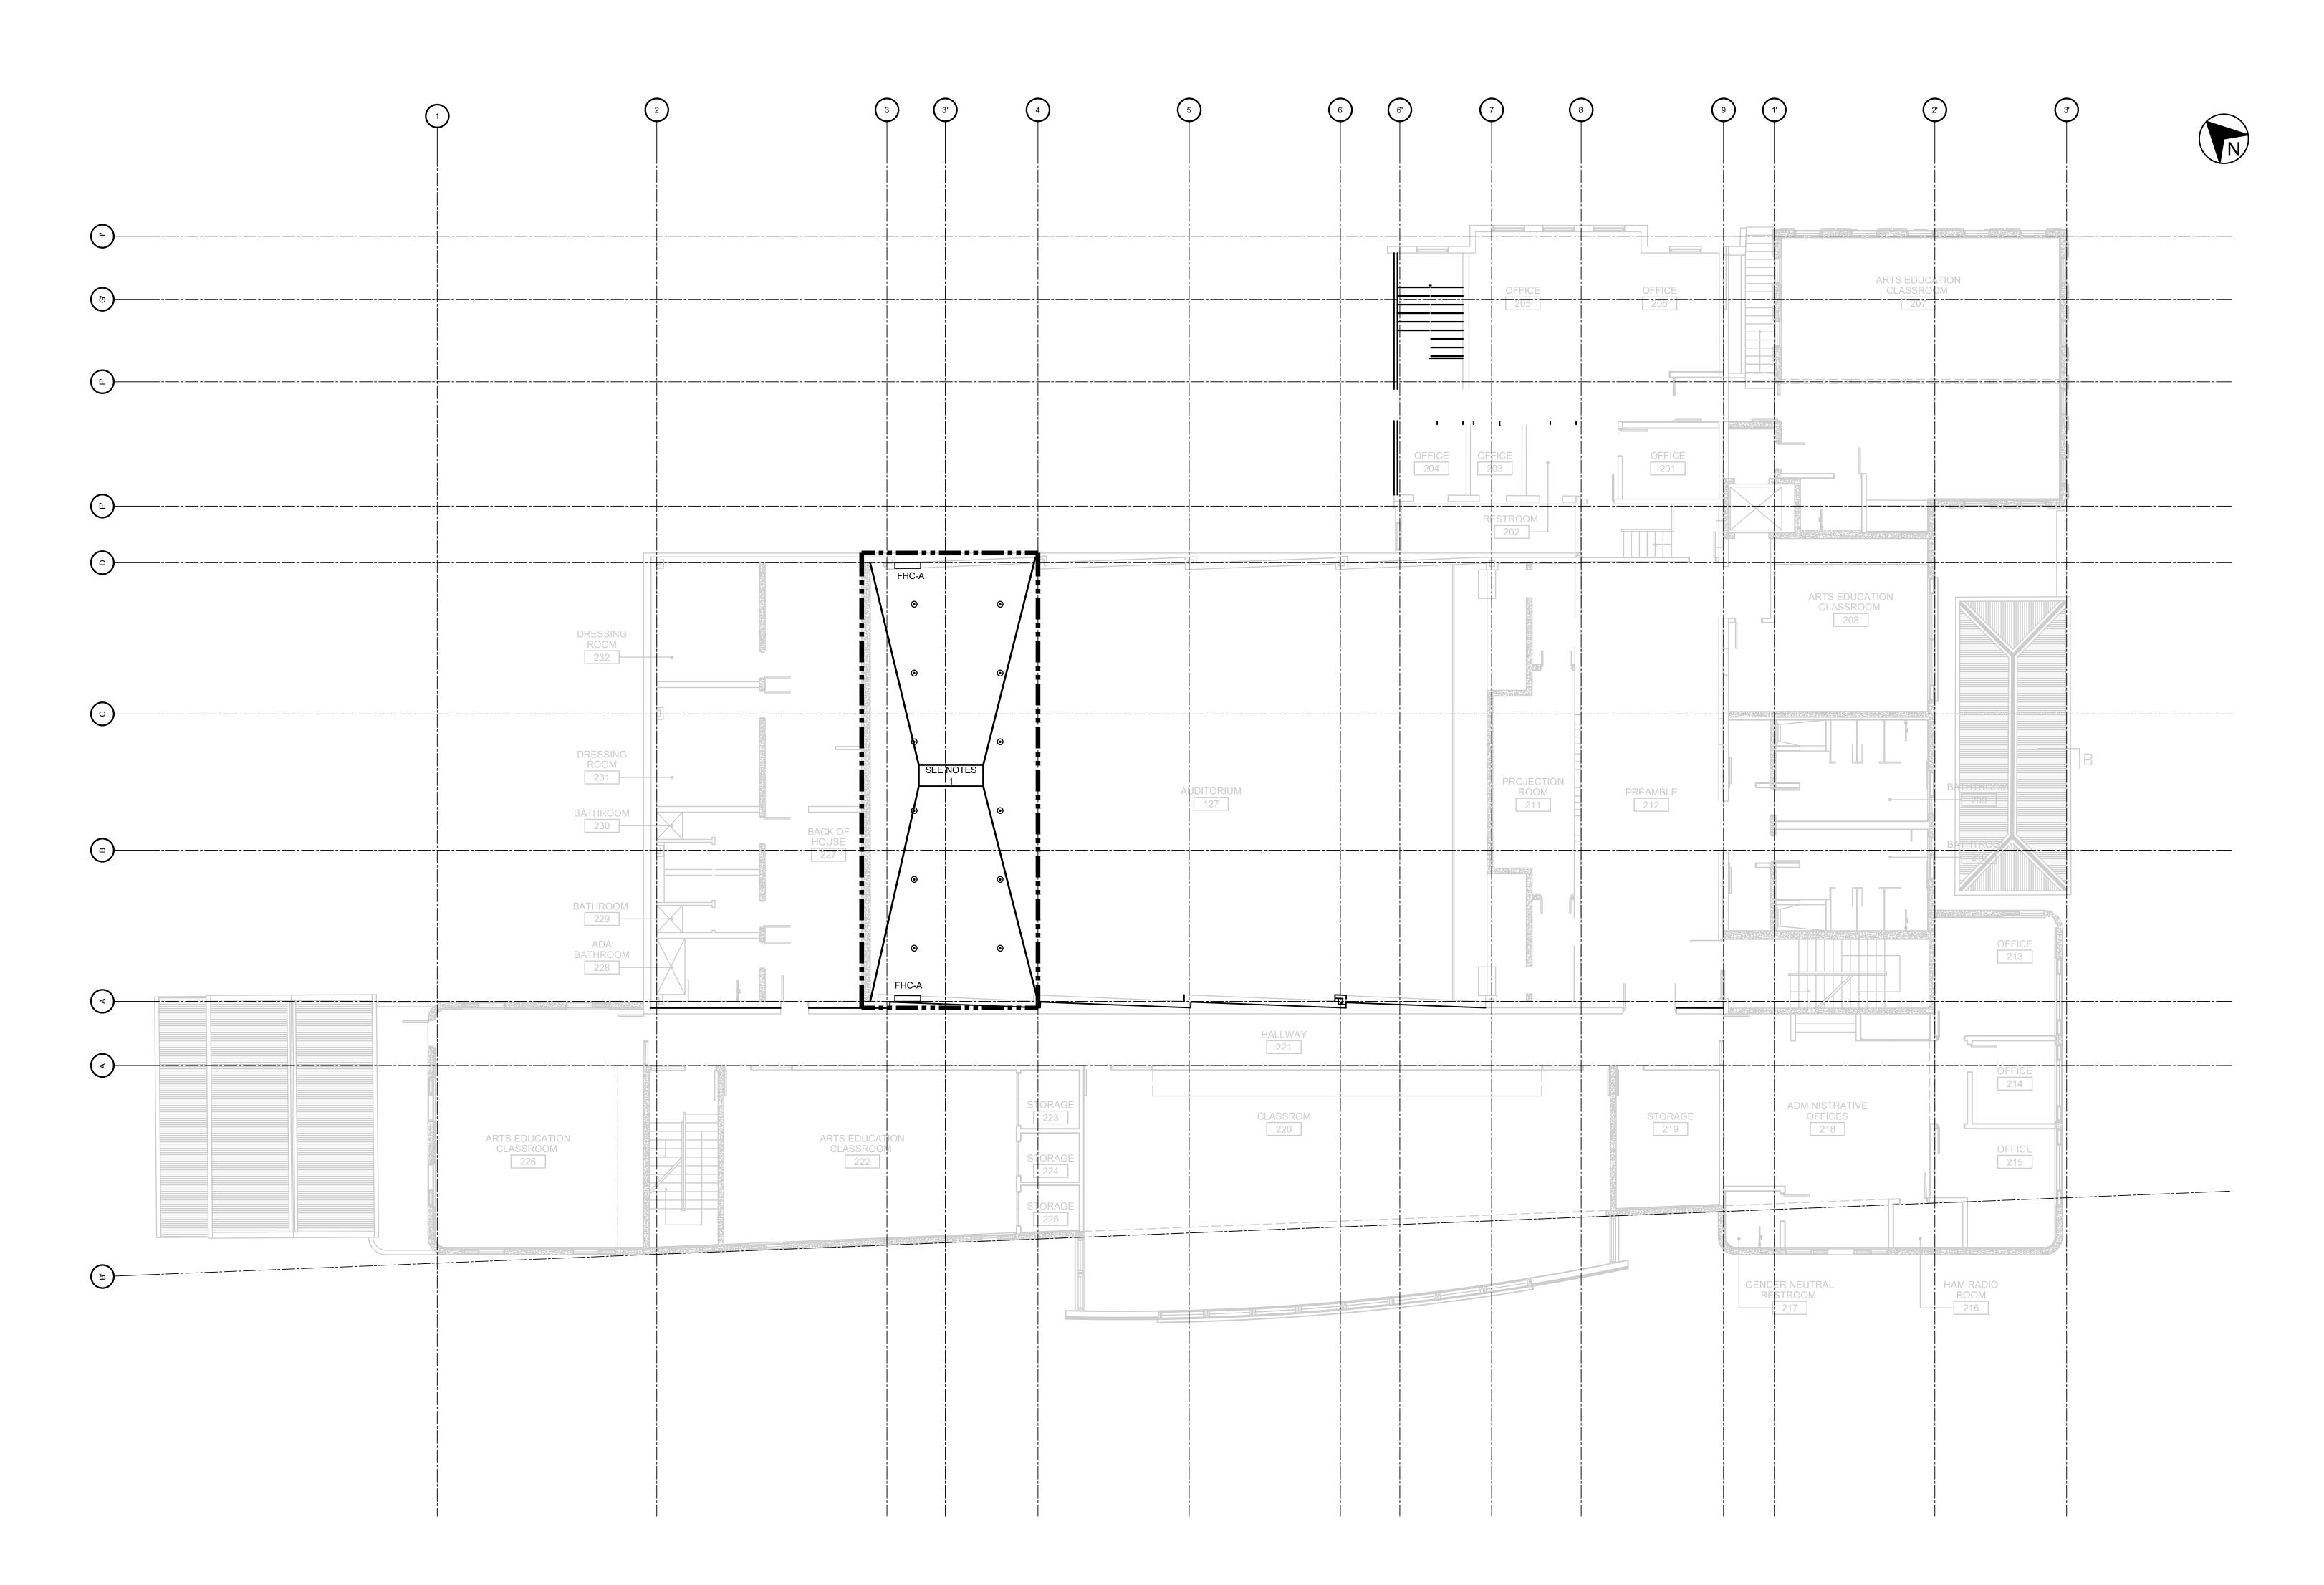
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FIRE PROTECTION NOTES.

SCHEDULES & DETAILS

FP1-00



FIRE PROTECTION - SECOND FLOOR PLAN
SCALE: 1/8"=1'-0"

_____ ORDINARY HAZARD GROUP 2 DENSITY SHALL BE 0.2 GPM/SQFT OVER HYDRULICALLY MOST REMOTE CALCULATED AREA OF 1,500 CONTRACTOR SHALL SUBMIT ALL HYDRAULIC& SEISMIC CALCULATIONS, SHOP DRAWINGS AND EQUIPMENT SUBMITTAL 3. CONTRACTOR SHALL FOLLOW NFPA 13 (LATEST EDITION) FOR FIRE PROTECTION SYSTEM INSTALLATION. SPRINKLER HEADS ARE SHOWN FOR REFERENCE ONLY. FINAL LOCATION OF SPRINKLER HEADS SHALL BE INDICATED IN SHOP DRAWINGS.

•

WORK LIMITED TO OUTLINED AREA ONLY

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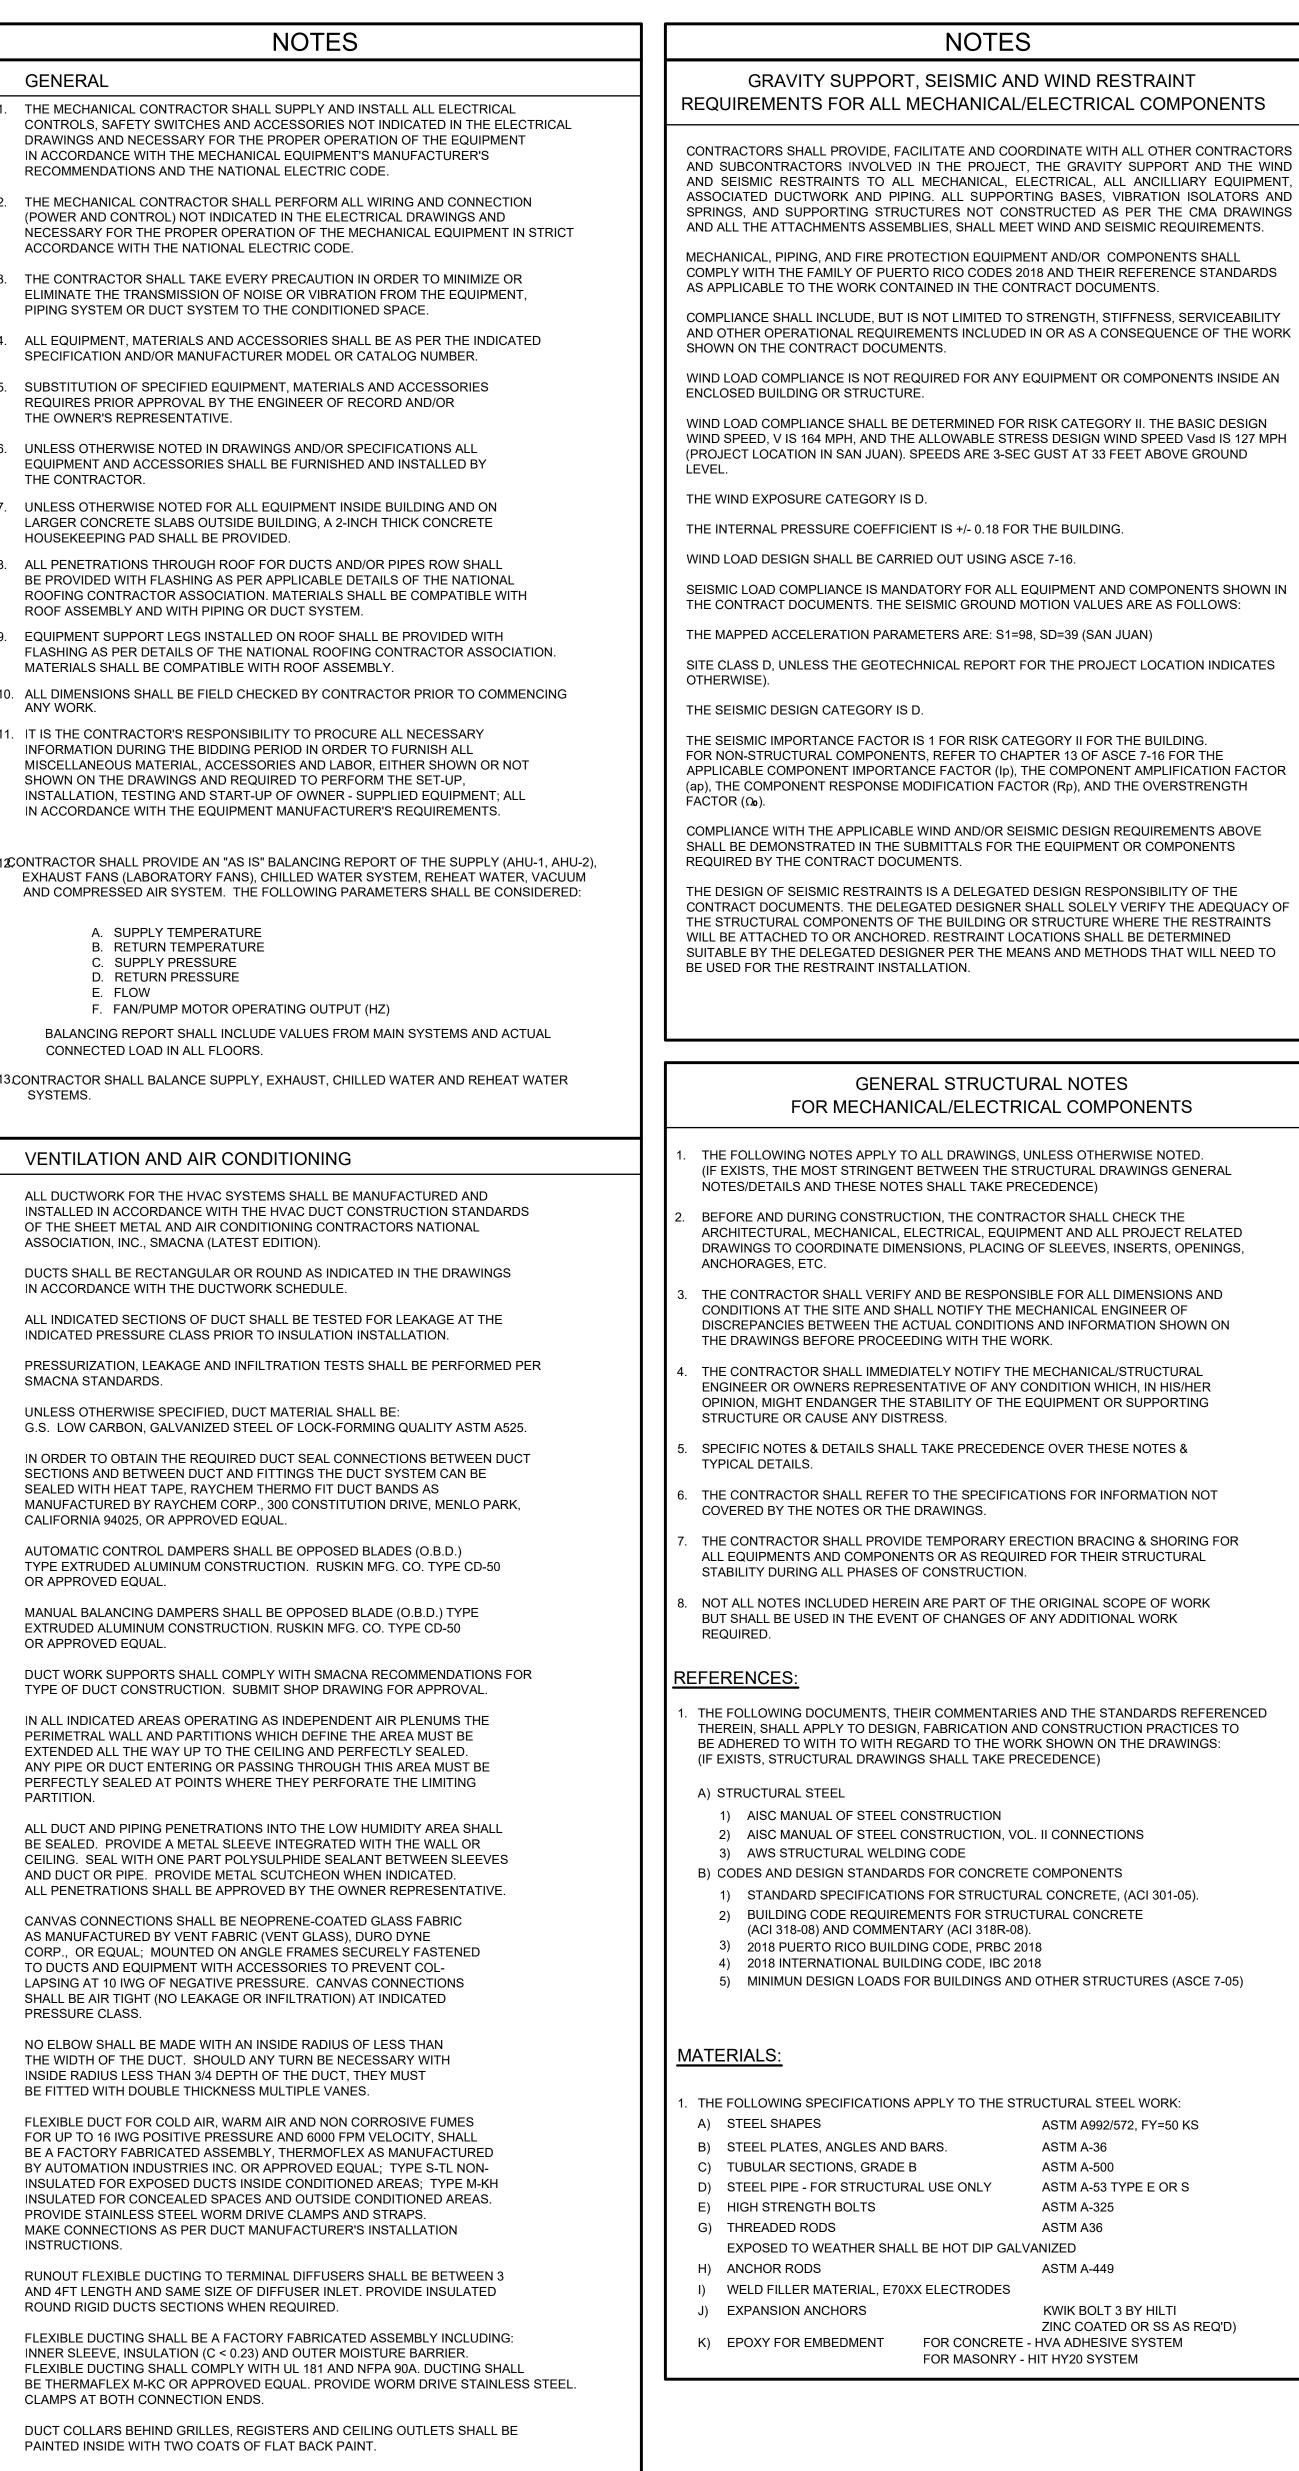
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FIRE PROTECTION 2ND LEVEL FLOOR PLAN

SHEET TITLE

FP2-02



FABRICATION OF ANY ELEMENT. **HVAC DRAWING SYMBOLS** ACCESS DOOR OR ACCESS PANEL TRANSITIONS: GIVE SIZES. NOTE: F.O.T.-FLAT ON TOP F.O.B.-FLAT ON BOTTOM GOOSENECK HOOD (IF APPLICABLE) RECTANGULAR OR SQUARE DUCT. FIRST NUMBER INDICATES DIMENSION TURNING VANES IN DUCT ELBOWS 10''x12'' OF SIDE SHOWN.SECOND NUMBER INDICATES SIDE NOT SHOWN. INTERNALLY - LINED DUCT 10''x12'' INCLINED DROP IN RESPECT TO AIR FLOW (NUMBERS INDICATE INSIDE DIMENSIONS) INCLINED RISE IN RESPECT TO AIR FLOW SUPPLY DUCT SECTION-FIRST NUMBER INDICATES HORIZONTAL DIMENSION INVIEW, SECOND NUMBER INDICATES VERTICAL DIMENSION IN VIEW. COIL WITHIN DUCT EXHAUST OR RETURN DUCT SECTION-FIRST NUMBER INDICATES HORIZONTAL DIMENSION IN VIEW, SECOND NUMBER INDICATES VERTICAL DIMENSION IN VIEW. FLEXIBLE DUCT CONNECTION SUPPLY DUCT TURNING TOWARD VIEWER OPPOSED BLADE DAMPERS SUPPLY DUCT TURNING AWAY FROM VIEWER BACKDRAFT DAMPER RETURN OR EXHAUST DUCT TURNING TOWARD VIEWER RETURN OR EXHAUST DUCT TURNING SUPPLY DIFFUSER AWAY FROM VIEWER MOTOR OPERATED DAMPER (PNEUMATIC OR ELECTRIC) RETURN DIFFUSER BALANCING (VOLUME) DAMPER XXX CFM INDICATES AIR FLOW SUPPLY REGISTER ─ VERTICAL POSITION → HORIZONTAL POSITION XXX CFM INDICATES AIR FLOW STANDARD BRANCH FOR SUPPLY RETURN DIFFUSER AND RETURN (NO SPLITTER) XX" X XX" ◀ INDICATES NECK SIZE XXX CFM INDICATES AIR FLOW AIR FLOW (UNDUCTED) **→** AIR FLOW (DUCTED) SUPPLY OR RETURN/ **EXHAUST REGISTER GRILLE**

UNDUCTED AIRFLOW

Ø@Ø@_M

OPPOSED BLADE DAMPER

(AUTOMATIC OPERATION)

OPPOSED BLADE DAMPER

VARIABLE FREQUENCY DRIVE

(MANUAL OPERATION)

ROOM THERMOSTAT

FIRE DAMPER

STRUCTURAL STEEL

SHALL APPLY:

A) WELD SIZE

B) BOLT DIAMETER

C) PLATE THICKNESS

B) A HEAVY HEX NUT

D) CLIP ANGLE THICKNESS

2. ONE BOLT ASSEMBLY SHALL CONSIST OF:

A) A HEAVY HEX STRUCTURAL BOLT

A HARDENED STEEL WASHER

AND PAINTED WITH ZINC RICH PRODUCTS.

UNLESS OTHERWISE NOTED, THE FOLLOWING MINIMUMS

. ALL WELDING SHALL BE PERFORMED BY CERTIFIED WELDERS USING THE ELECTRIC

ARC PROCESS IN ACCORDANCE WITH APPLICABLE PORTIONS OF THE "CODE FOR

ARC AND GAS WELDING INBUILDING CONSTRUCTION OF THE AMERICAN WELDING

SHOP DRAWINGS SHALL BE SUBMITTED TO THE ENGINEER FOR APPROVAL PRIOR

I. ALL WELDS AND BURNED AREAS SHALL BE CLEANED, PREPARED AND PRIMED

1/4" (ALL AROUND)

1/4" OR 3/8" EXPOSED TO WEATHER

1/4" OR 5/16" EXPOSED TO WEATHER

HVAC ABBREVIATIONS AMPERES INSIDE DIAMETER ACCESS DOOR INCH(ES) ABOVE FINISHED FLOOR INSULATION ACCESS PANEL KILOWATT ASHRAE AMERICAN SOCIETY OF HEATING, REFRIGERATION AND AIR-LABORATORY CONDITIONING ENGINEERS LEAVING AIR TEMPERATURE ATTEN ATTENUATOR LBS/HR POUNDS PER HOUR **BACKDRAFT DAMPER** LEAVING WATER TEMPERATURE BUTTERFLY DAMPER BFD **BLAST GATE** MAX **BRAKE HORSEPOWER** UNITS OF THOUSANDS BTU/HR BLDG BUILDING MECHANICAL BOD **BOTTOM OF DUCT** BOS BOTTOM OF STEEL MANUFACTURER **BRITISH THERMAL UNIT** MINIMUM BTUH BRITISH THERMAL UNIT PER HOUR MATERIAL **CONSTANT EXHAUST** MTR MOTOR CFM **CUBIC FEET PER MINUTE** NORMALLY CLOSED **CENTER LINE** (MANUAL OPERATION) COLUMN COL NATIONAL ELECTRIC CODE CONC CONCRETE NOT IN CONTRACT CONNECTION NECK DIAMETER CONTINUATION NORMALLY OPEN CONTR CONTRACT(OR) (MANUAL OPERATION) DECIBEL NUMBER DRY BULB TEMPERATURE NOT TO SCALE **DOOR GRILLE** DIAMETER OUTSIDE AIR DIFF DIFFUSER **OUTDOOR AIR DAMPER** OUTDOOR AIR INTAKE/INLET DIFFERENTIAL PRESSURE GAUGE OPPOSED BLADE DAMPER ON CENTER DEW POINT TEMPERATURE OUTSIDE DIAMETER DWG OPENING OUNCE EXHAUST AIR ENTERING AIR TEMPERATURE EAT PRESSURE DROP EDR **EQUIVALENT DIRECT RADIATION** PRE-FILTER ELEVATION ELEC ELECTRIC (ELECTRICAL) PARTS PER MILLION EQUIP **EQUIPMENT** PRESSURE ESP EXTERNAL STATIC PRESSURE POUNDS PER SQUARE INCH ENTERING WATER TEMPERATURE EWT POUNDS PER SQUARE INCH ABSOLUTE EXH EXHAUST POUNDS PER SQUARE INCH GAUGE **EXIST** EXISTING RETURN AIR FAHRENHEIT (DEGREES) RELATIVE HUMIDITY FACE AREA REVOLUTIONS PER MINUTE FAIL CLOSED SUPPLY AIR FINISHED FLOOR STANDARD CUBIC FEET PER HOUR FINISHED FLOOR ELEVATION STANDARD CUBIC FEET PER MINUTE FLOOR SQUARE FEET FLEXIBLE FLEX FLTR STATIC PRESSURE FILTER FLXC SPECIFICATIONS FLEXIBLE CONNECTOR FMD SQUARE FLOW MEASURING DEVICE STAINLESS STEEL FAIL OPEN STANDARD FOB FLAT ON BOTTOM FLAT ON TOP TEMPERATURE FEET PER MINUTE TOD TOP OF DUCT FOOT (FEET) TOP OF STEEL **TOTAL PRESSURE** FACE VELOCITY TOTAL STATIC PRESSURE TURNING VANE GAUGE GALV TYPICAL GALVANIZED VOLTS HEPA HIGH EFFICIENCY PARTICULATE VARIABLE AIR VOLUME AIR FILTER VOLUME DAMPER (MANUAL) HANGER HOR HORIZONTAL VELOCITY VERTICAL HORSEPOWER VARIABLE FREQUENCY DRIVE HEATING AND VENTILATING VELOCITY PRESSURE HEATING, VENTILATING AND AIR CONDITIONING WET BULB TEMPERATURE WATER GAUGE (COLUMN) WORKING POINT WATER PRESSURE DROP WEIGHT

HVAC DIAGRAM SYMBOLS

FLOW VALVE

VAV DIFFUSER

SUPPLY AIRFLOW

RETURN AIRFLOW

EXHAUST AIRFLOW

TRANSFER AIRFLOW

—··-

TEMPERATURE CONTROLLER

TEMPERATURE TRANSMITTER

FLOW CONTROLLER

SMOKE DETECTOR

TRANSMITTER

DIFFERENTIAL PRESSURE

FLOW TRANSMITTER

DUCT MOUNTED

VOLUME BOX

REHEAT COIL

CONSTANT VOLUME

EXHAUST VALVE

AIR MONITORING DEVICE



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ANALOG INPUT

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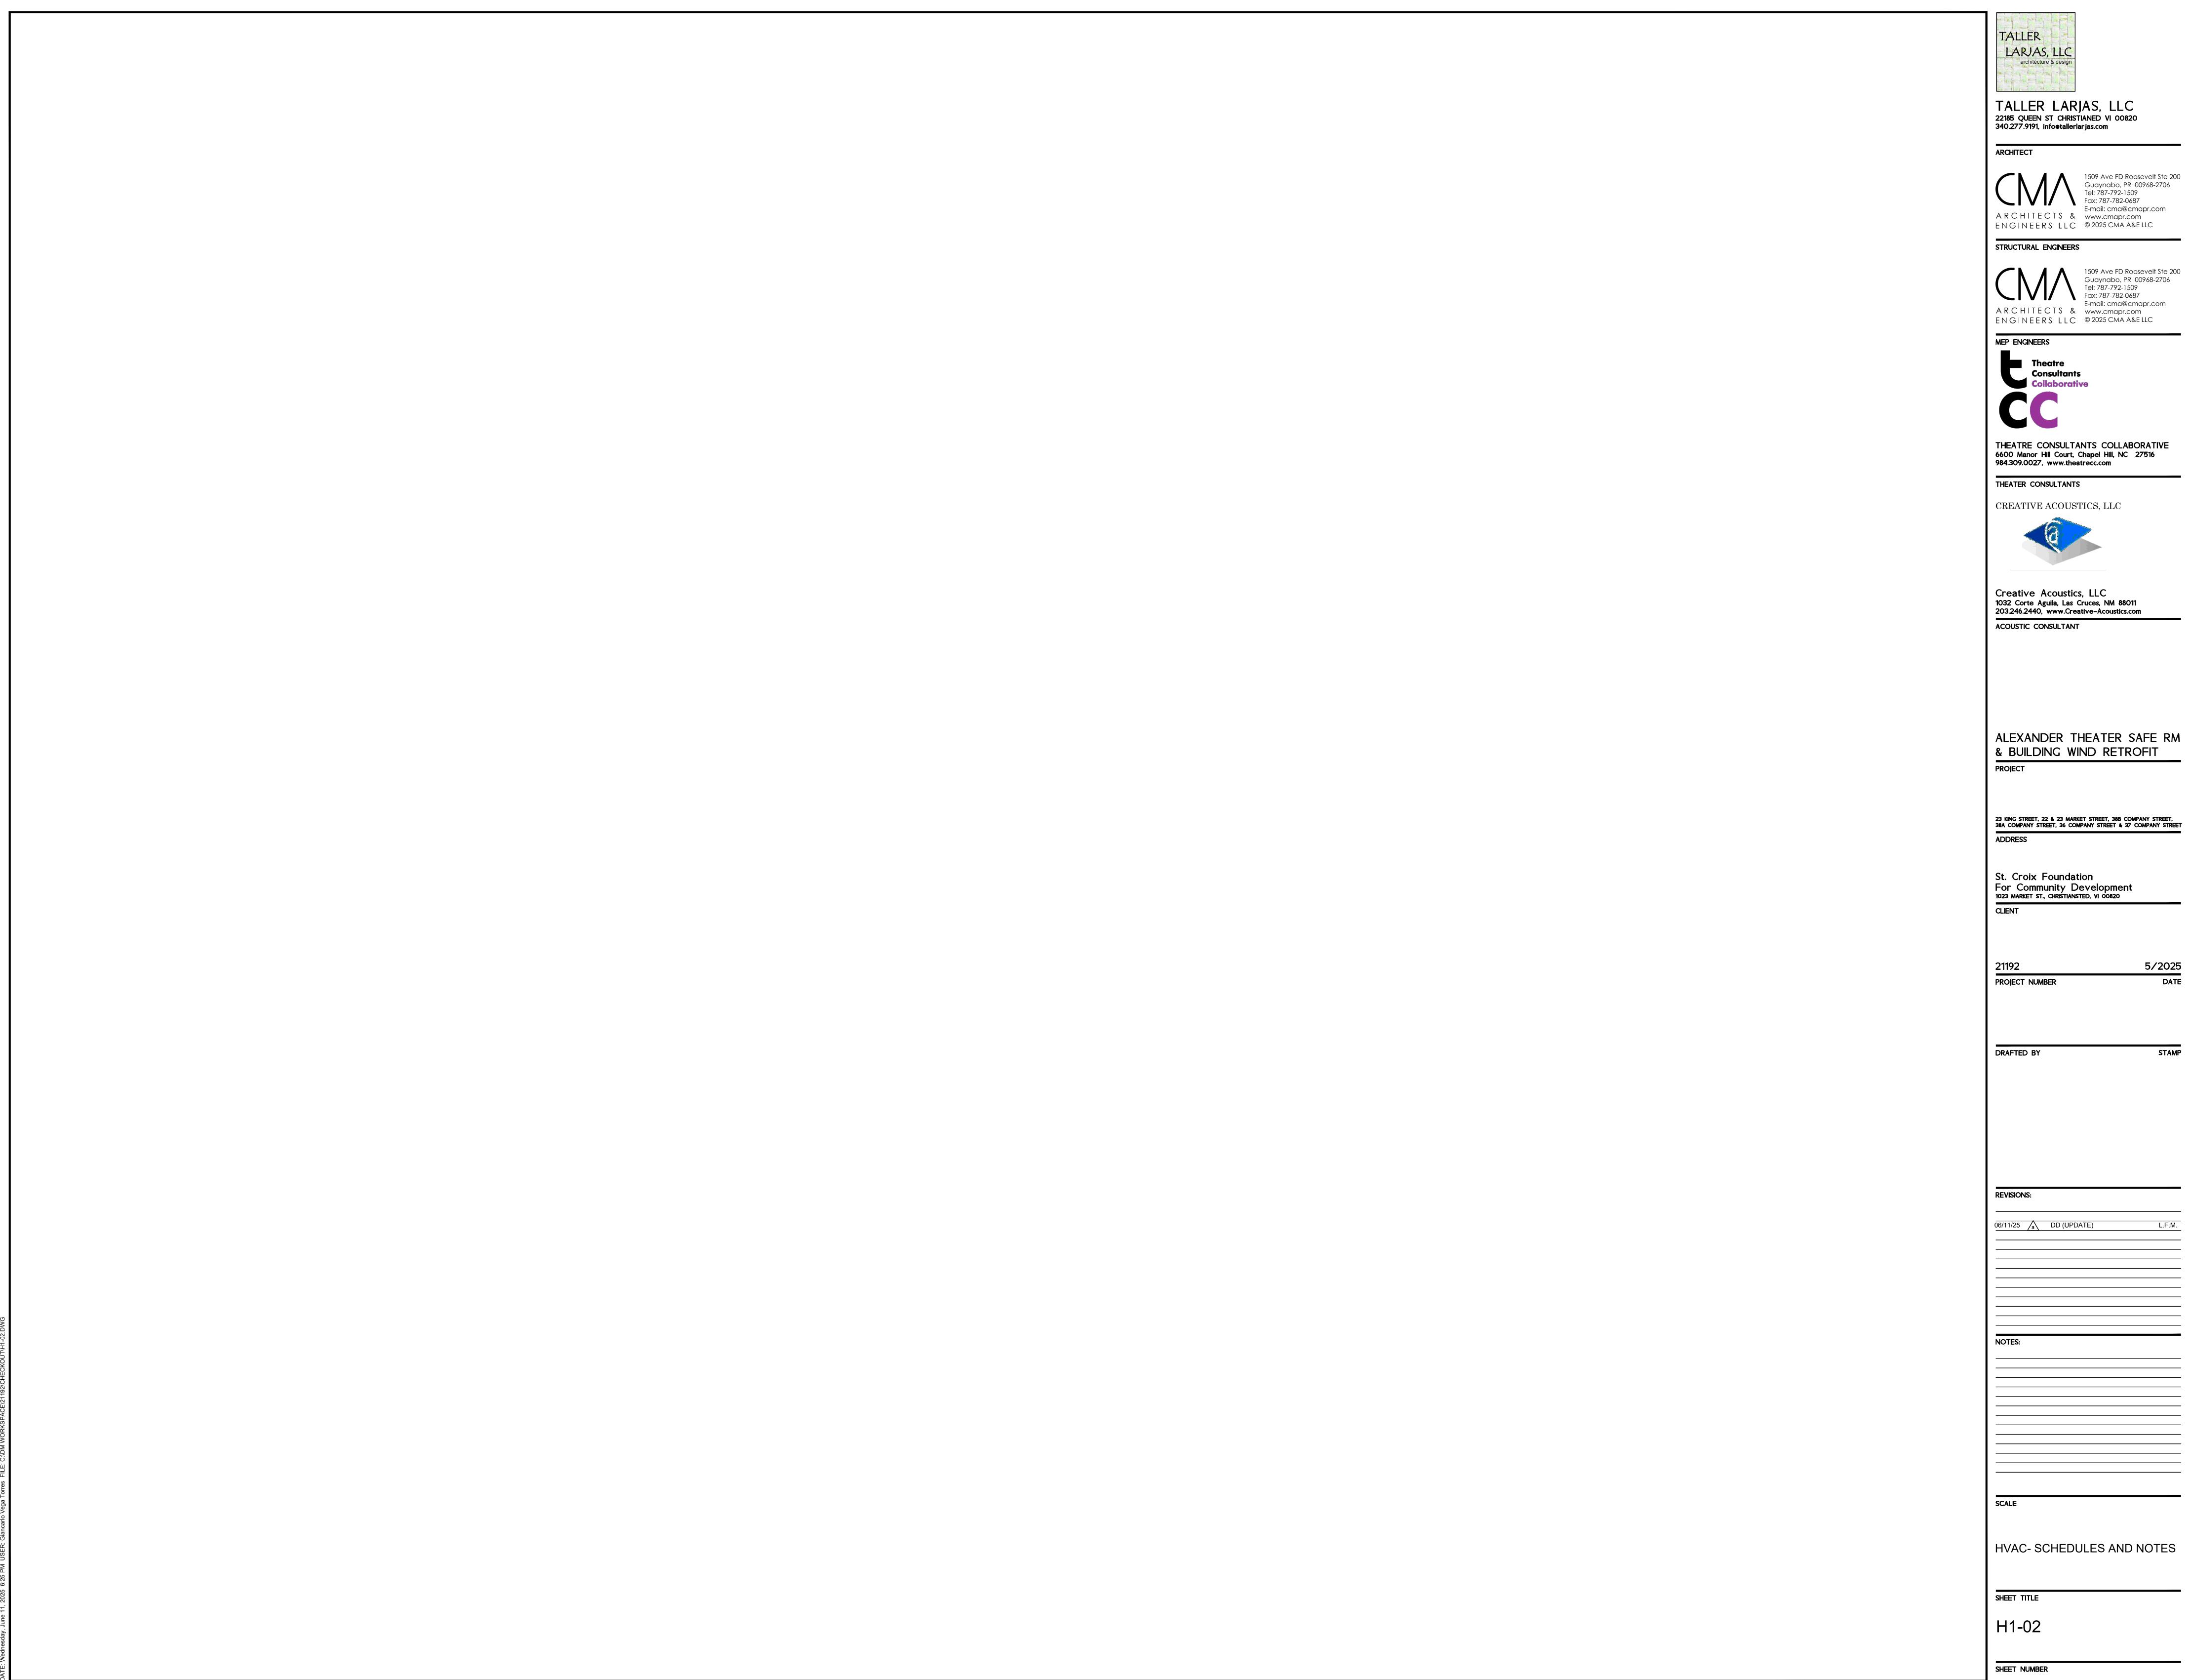
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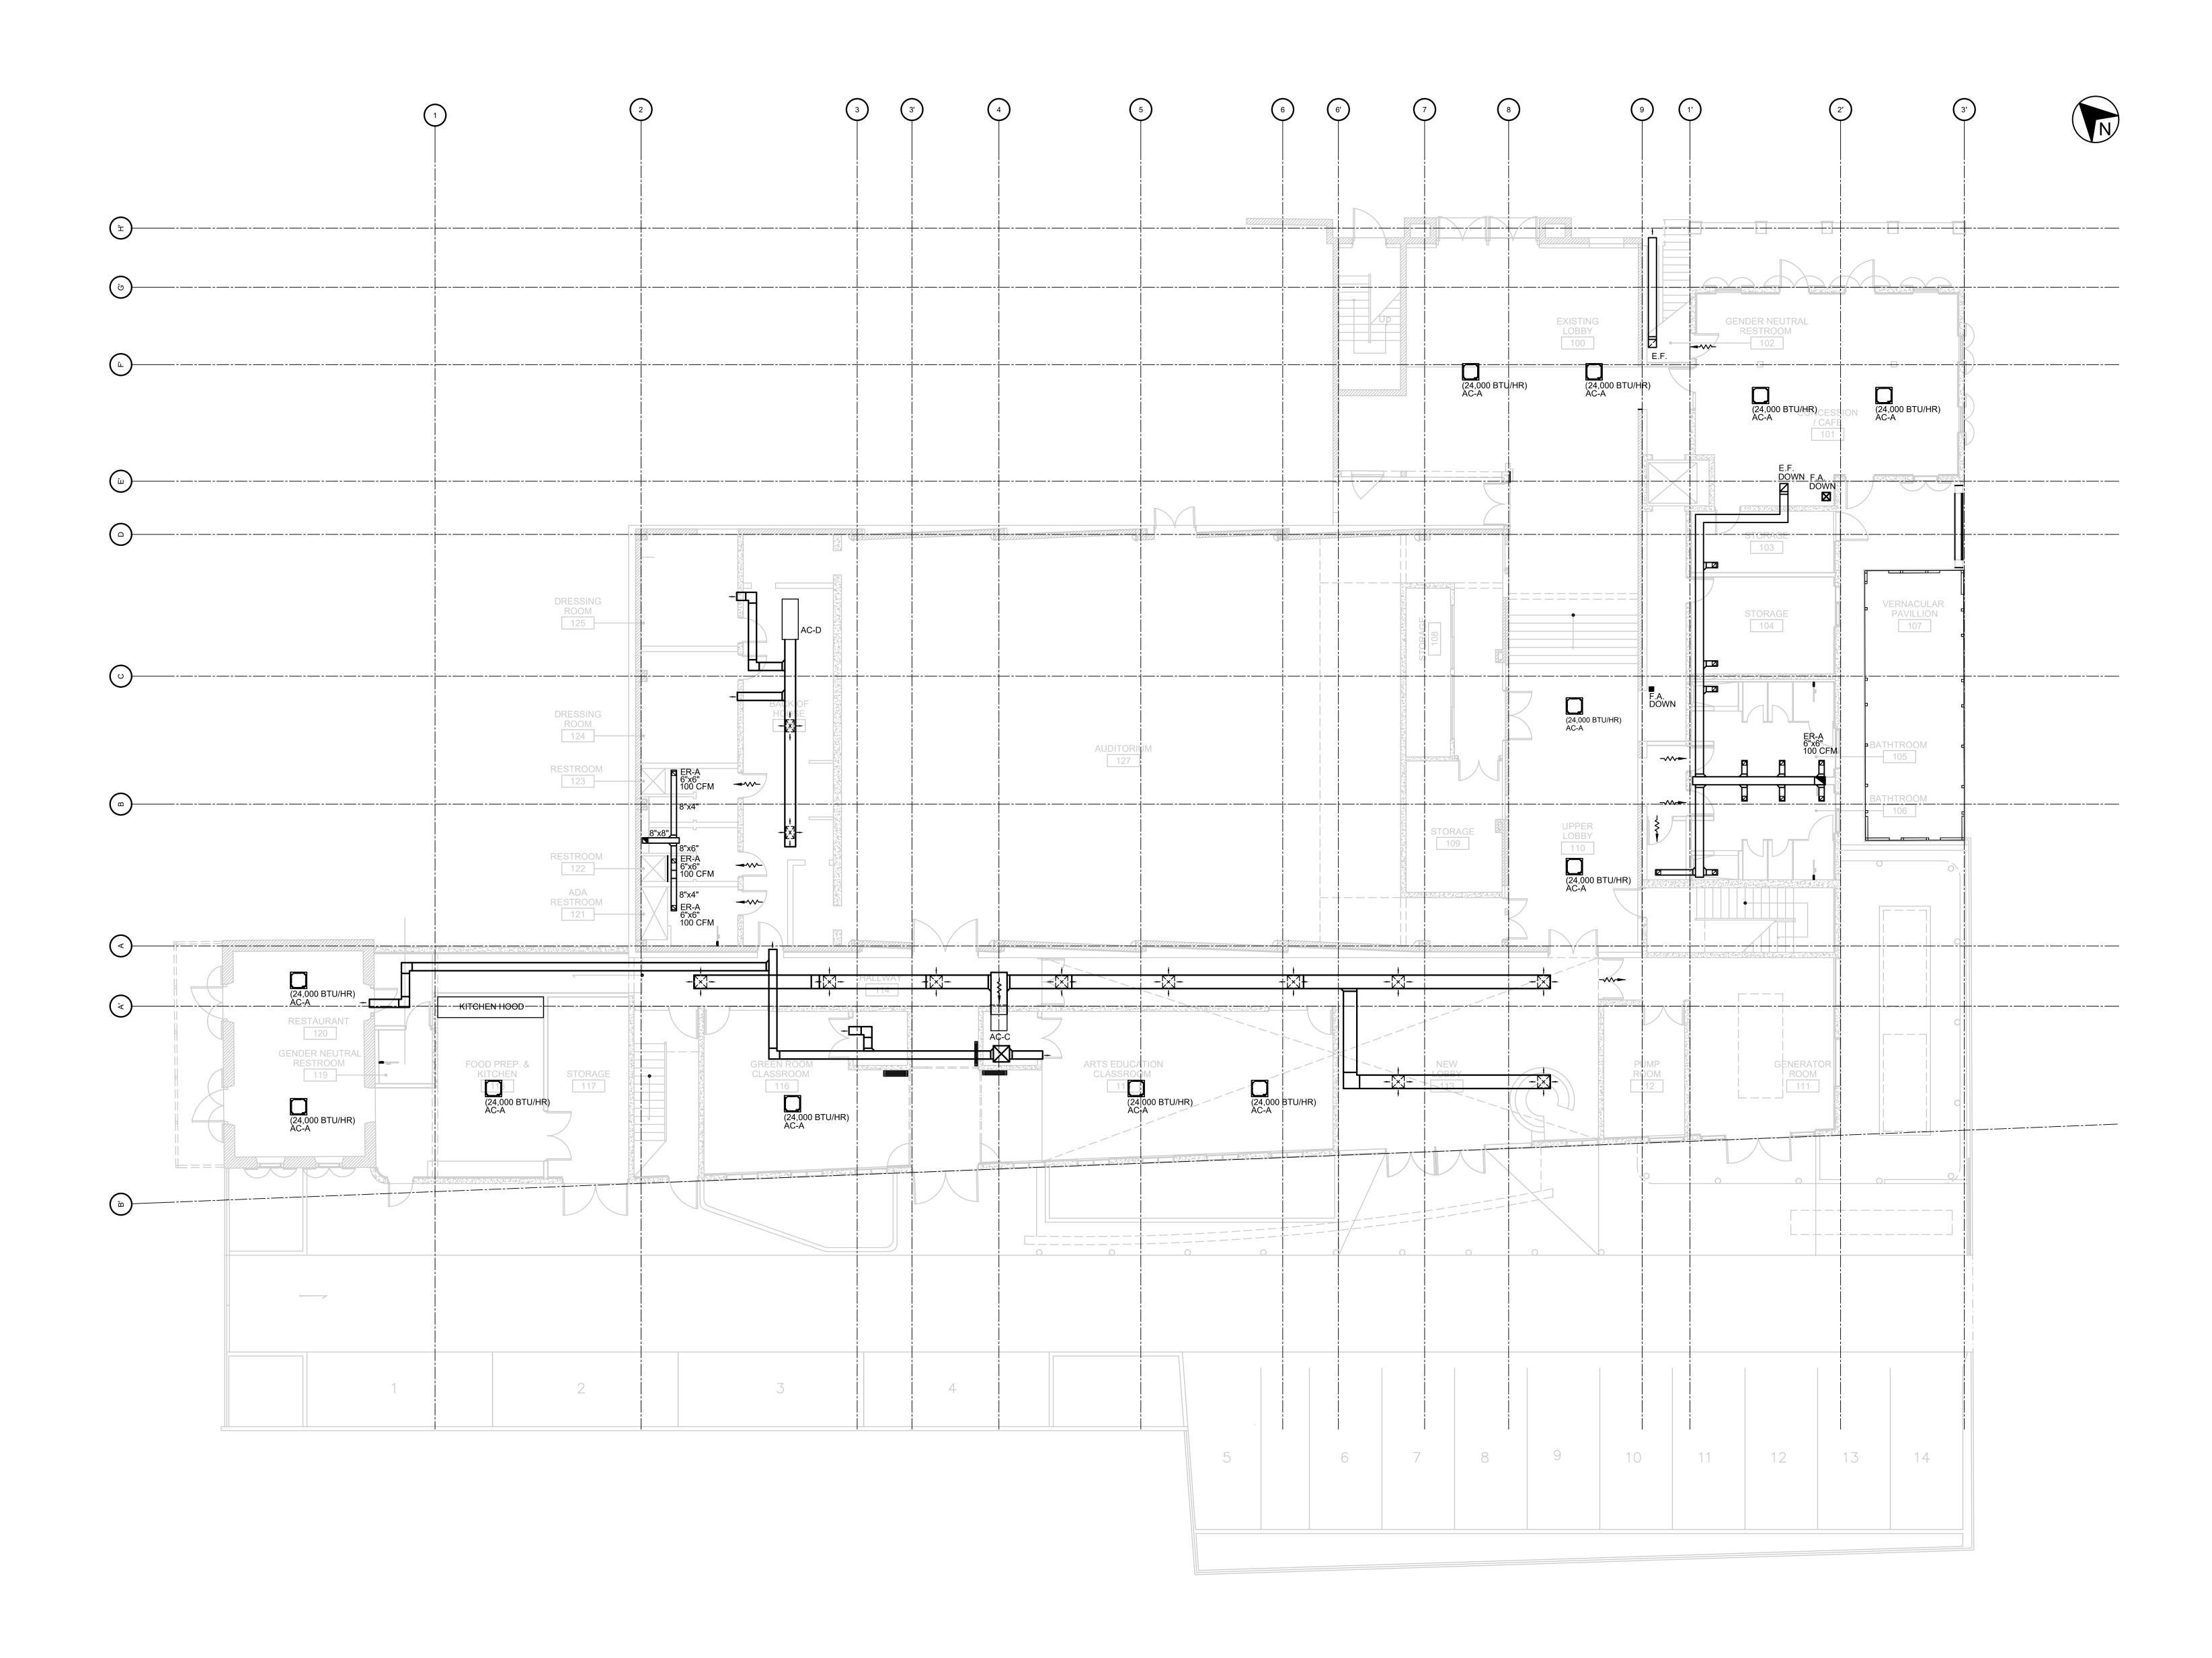
HVAC- NOTES & SYMBOLS

SHEET NUMBER

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5/2025 DATE



HVAC - FIRST FLOOR PLAN
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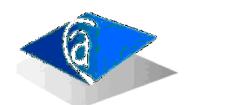


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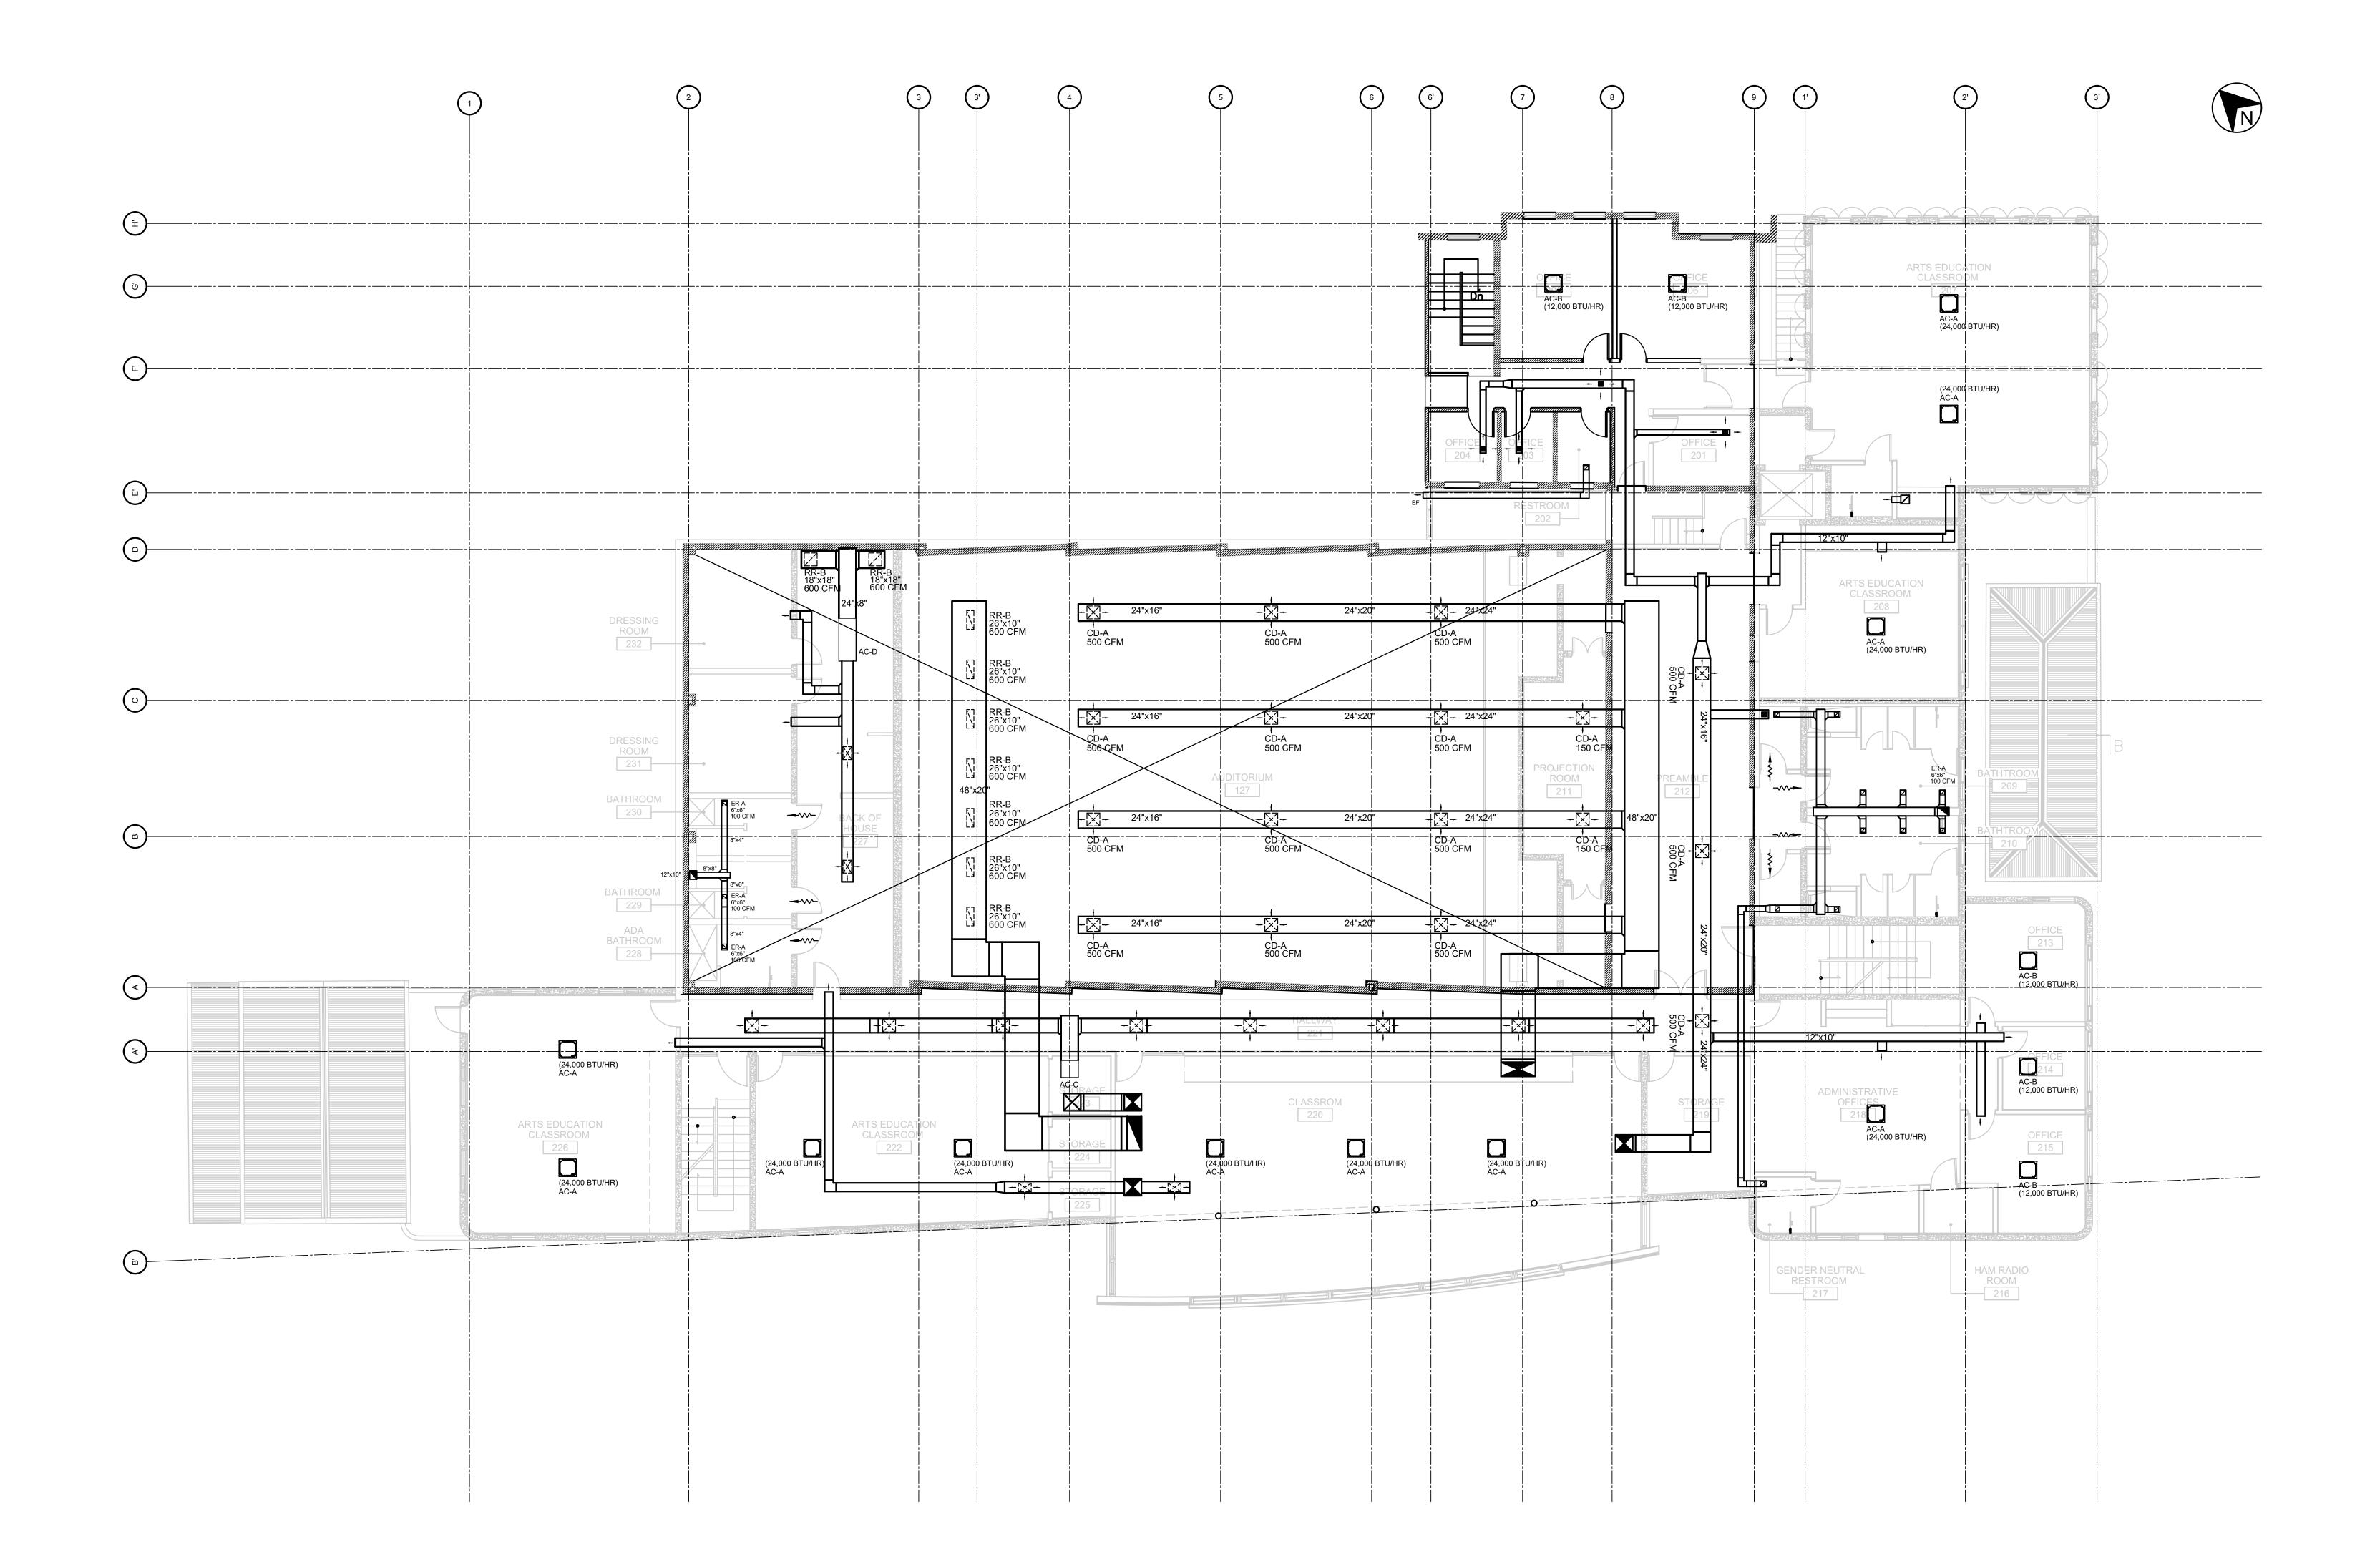
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REVISIONS:

HVAC- FIRST FLOOR PLAN

SHEET TITLE H2-01



HVAC - SECOND FLOOR PLAN
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architecture & design

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21192 5/2025
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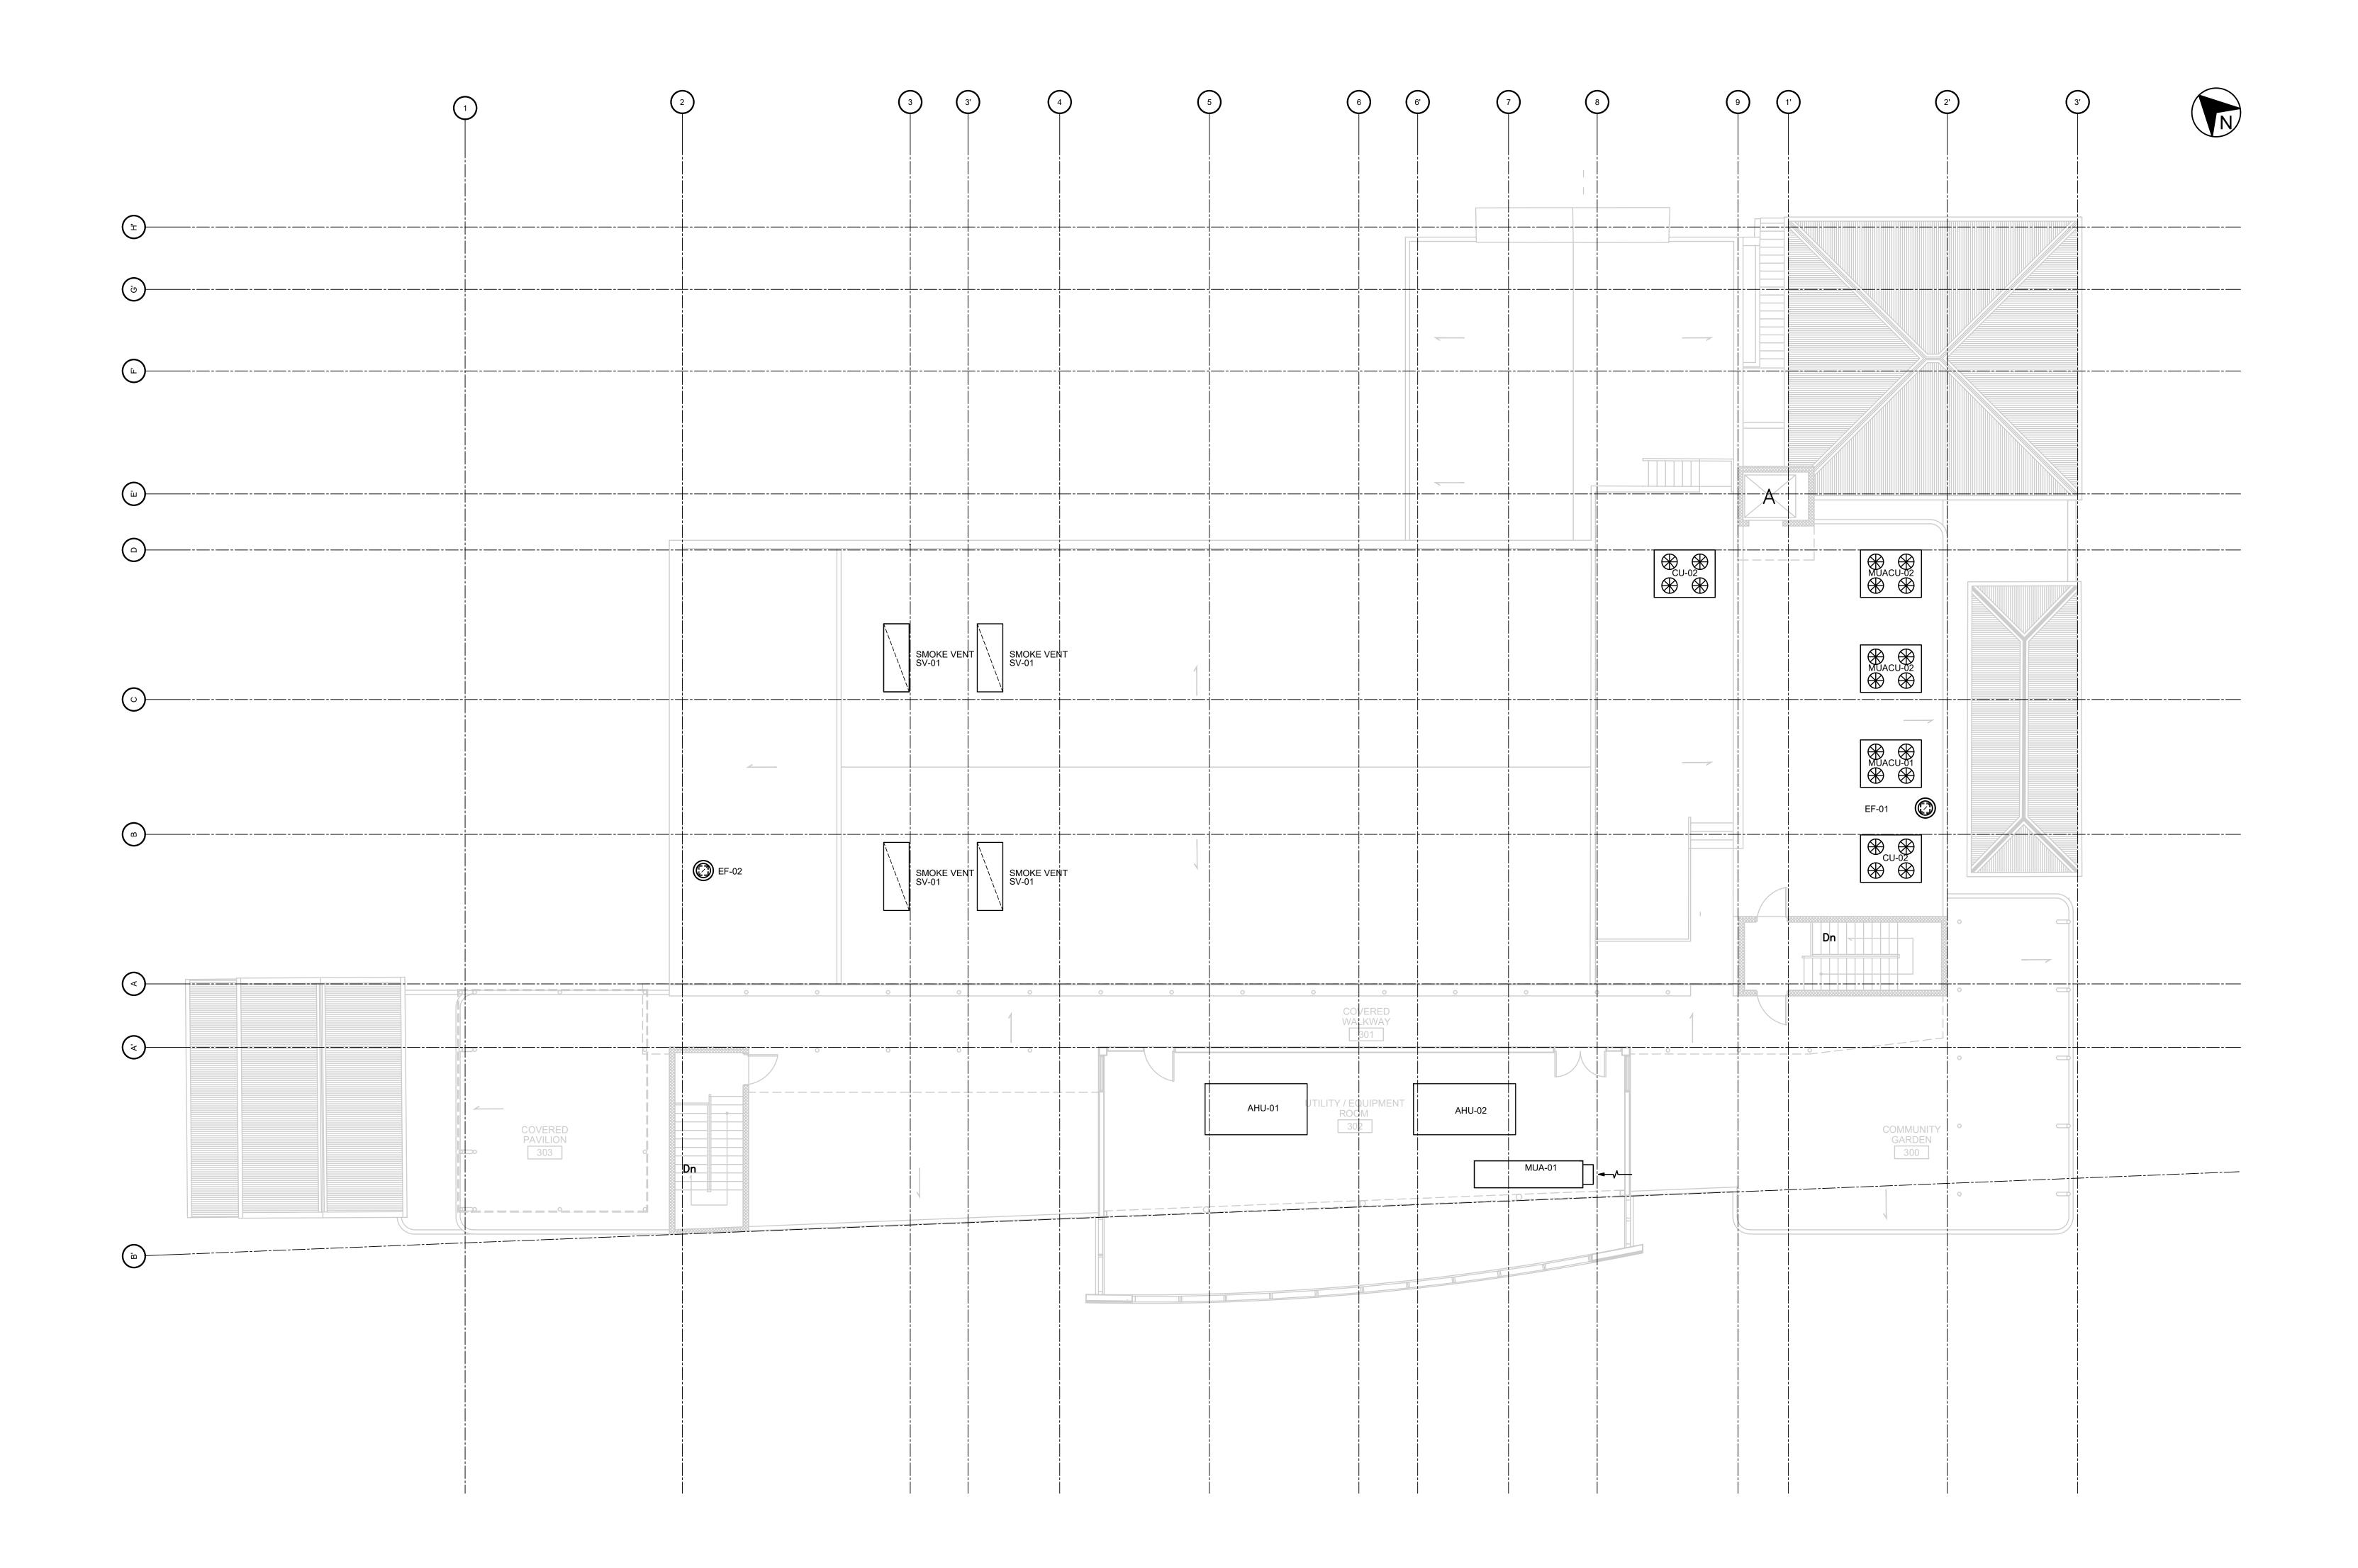
NOTE

SCALE

HVAC - SECOND FLOOR PLAN

SHEET TITLE

H2-02



HVAC - THIRD FLOOR PLAN

SCALE: 1/8"=1'-0"



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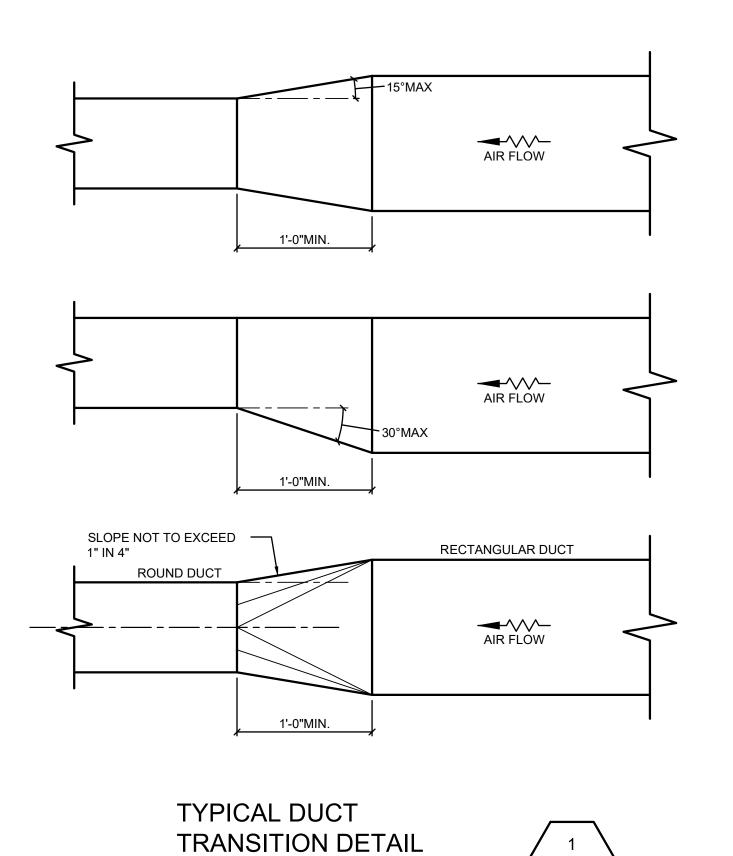
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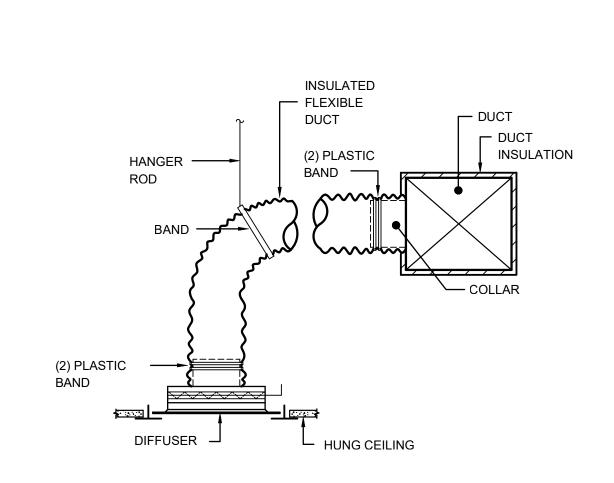
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HVAC - THIRD FLOOR PLAN


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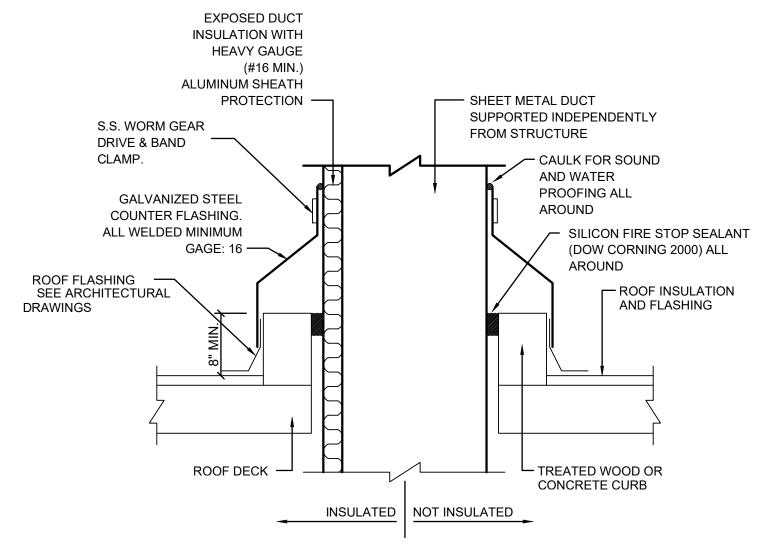











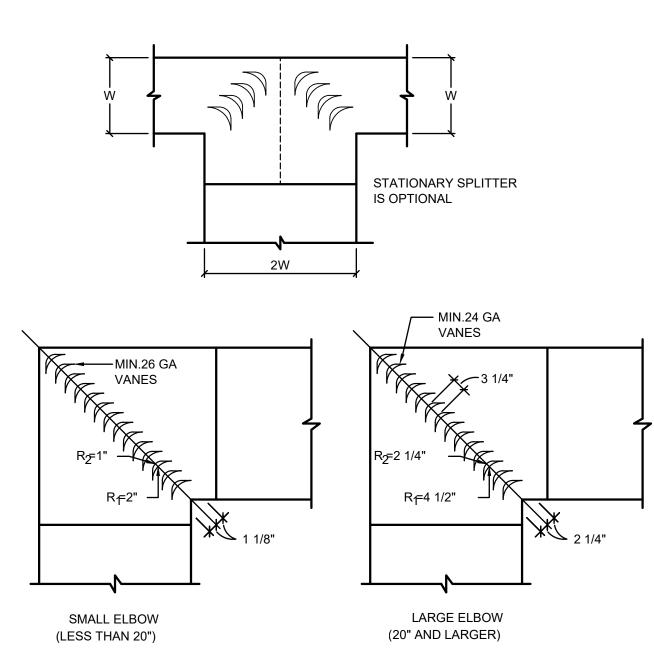


NOTE:

1- ALL WELDED JOINTS SHALL BE TREATED WITH A COMPATIBLE ANTICORROSION COATING FOR GALVANIZED SURFACES.



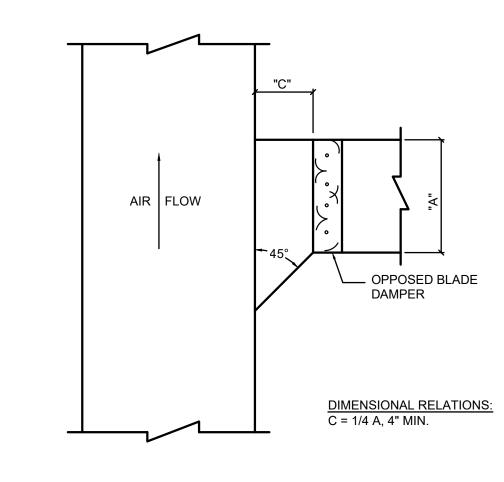



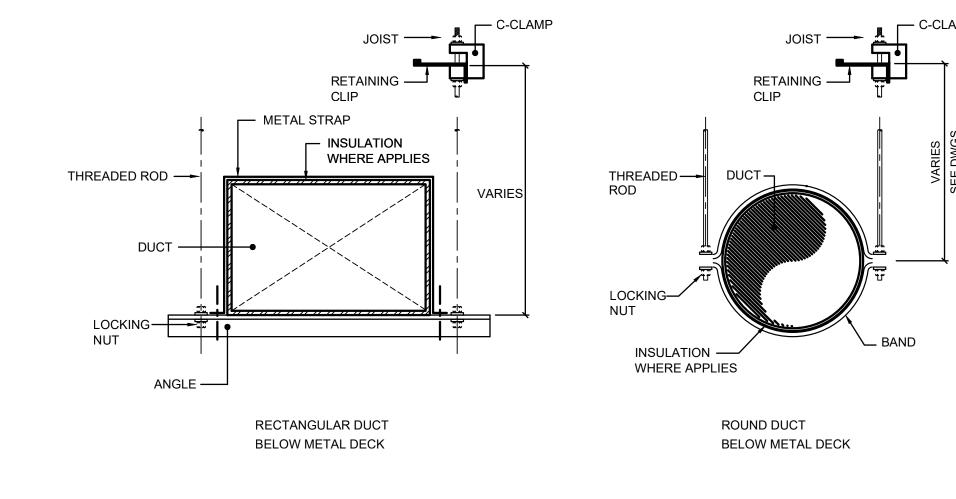



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203.246.2440, www.Creative-Acoustics.com
ACOUSTIC CONSULTANT

ALEXANDER THEATER SAFE RM & BUILDING WIND RETROFIT

23 KING STREET, 22 & 23 MARKET STREET, 38B COMPANY STREET, 38A COMPANY STREET & 37 COMPANY STREET

PROJECT

St. Croix Foundation
For Community Development
1023 MARKET ST., CHRISTIANSTED, VI 00820

 21192
 5/2025

 PROJECT NUMBER
 DATE

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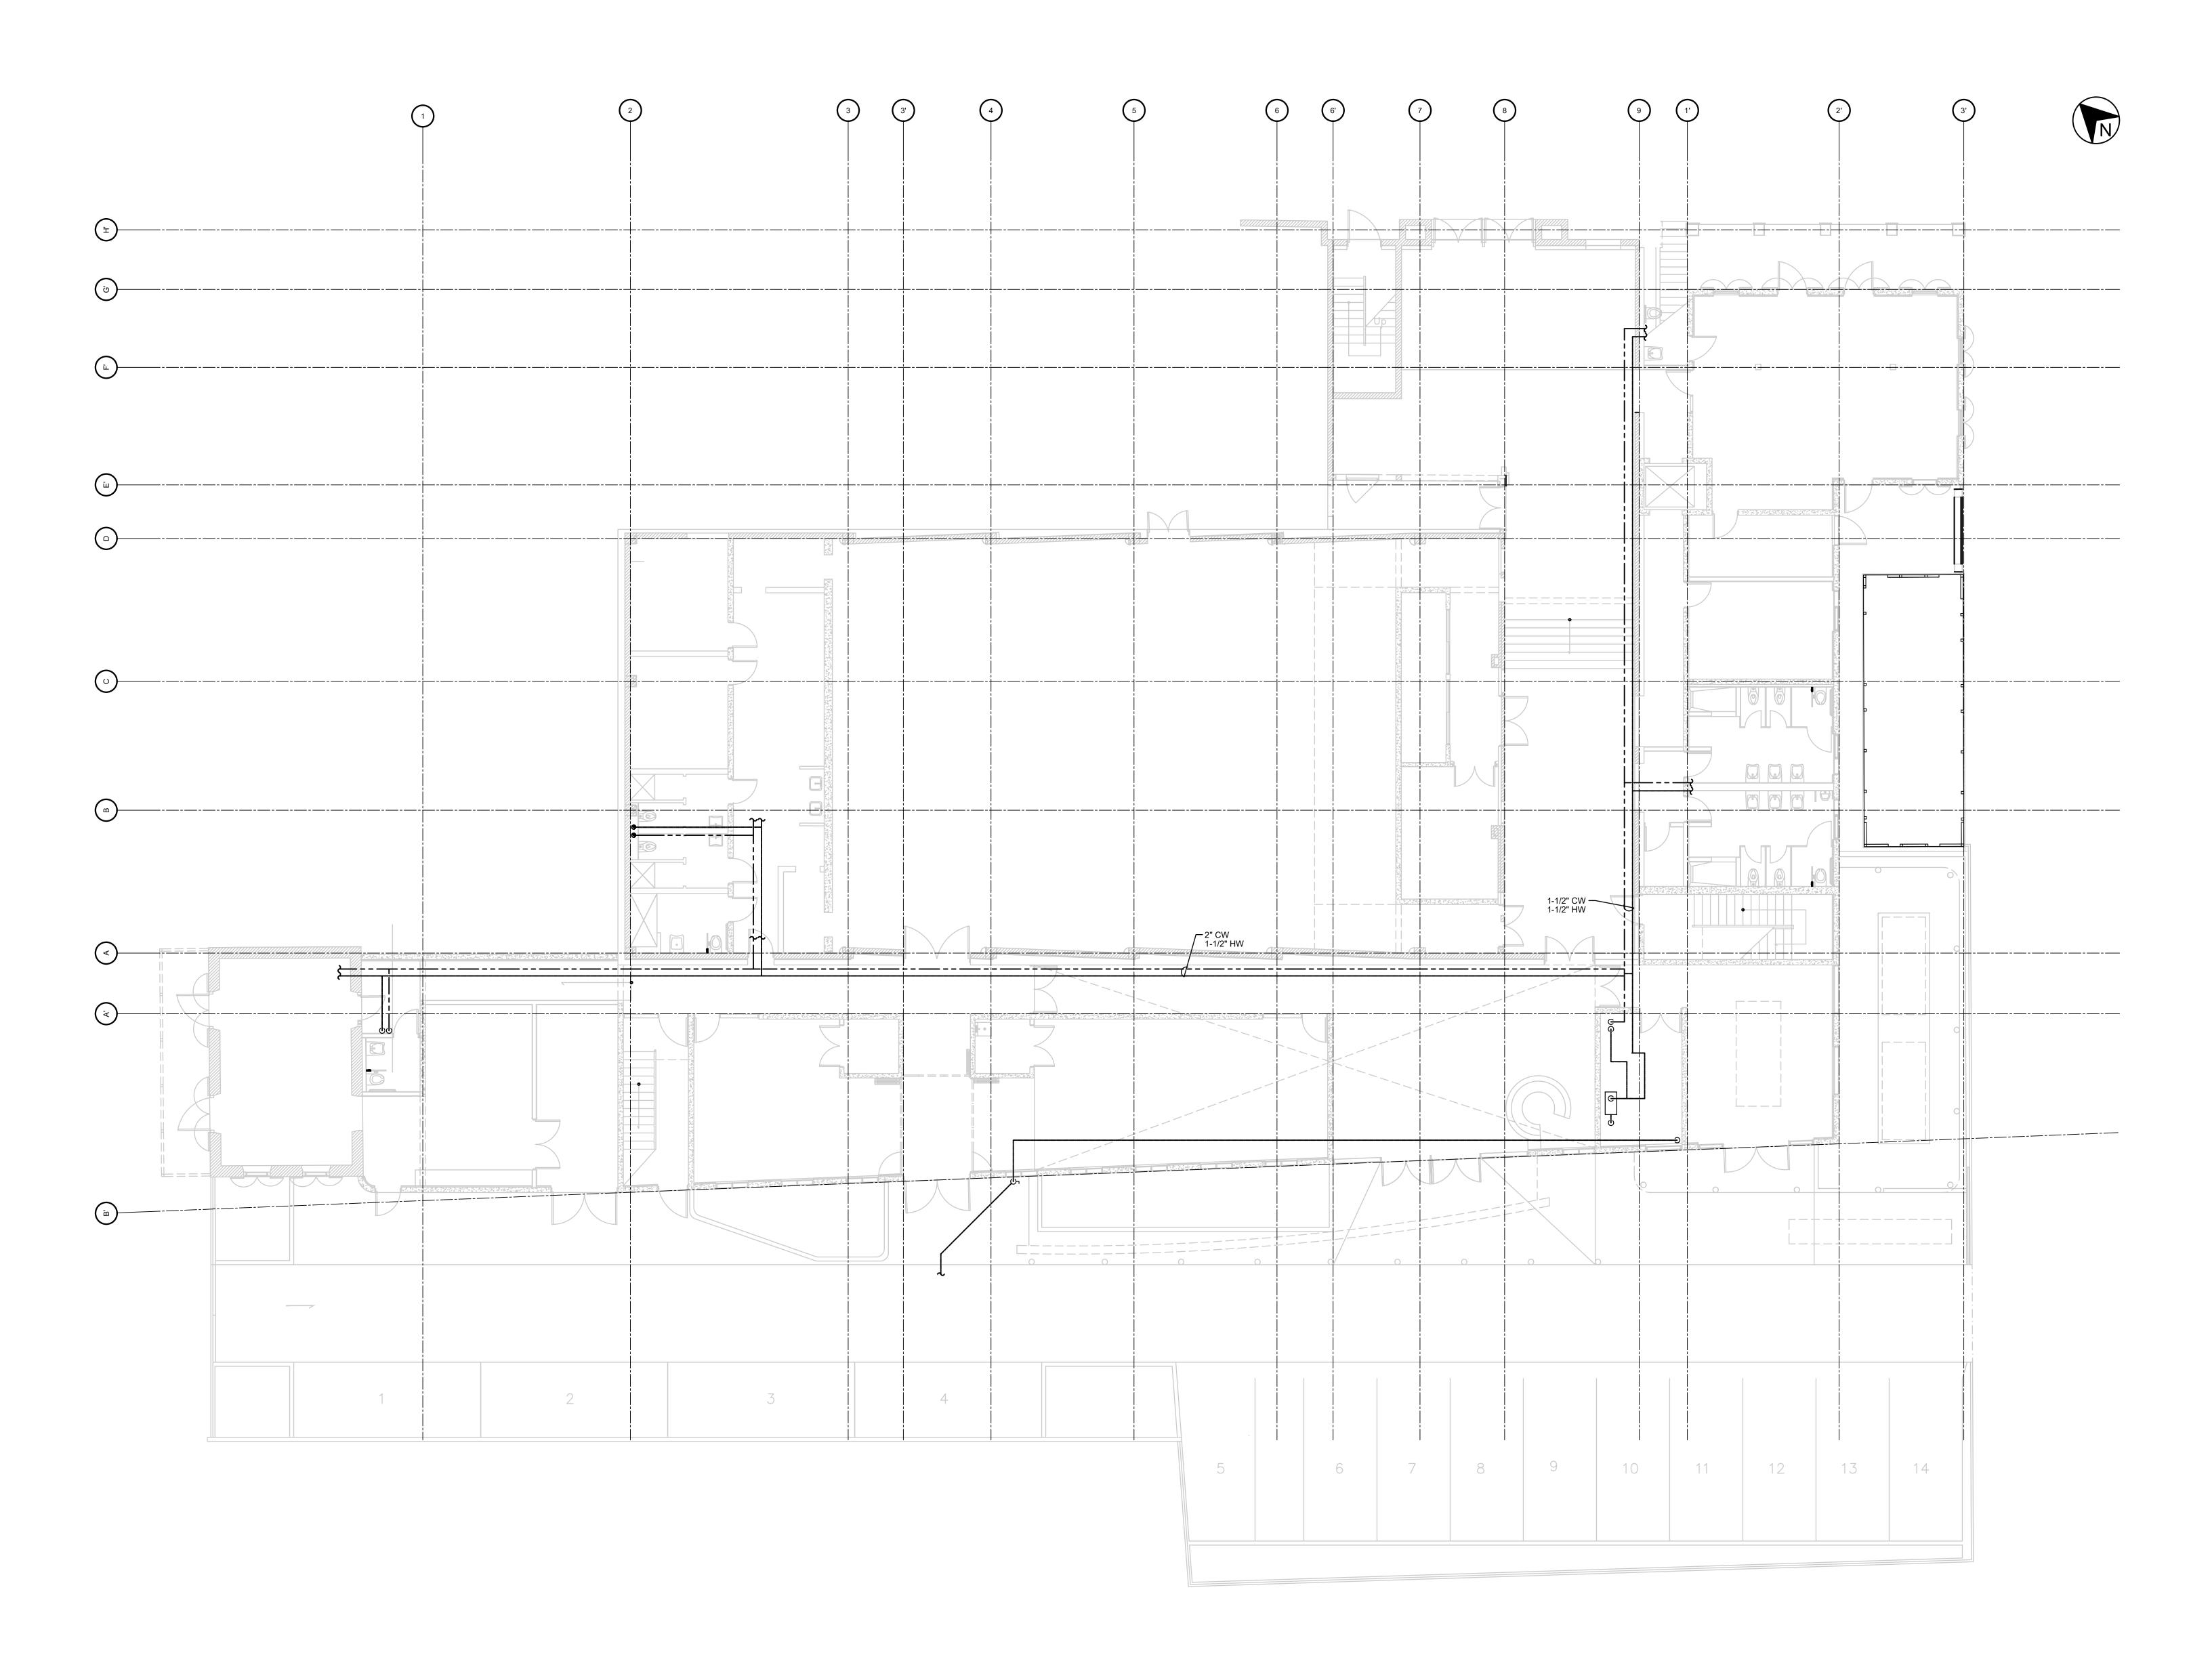
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HVAC DETAILS

H3-01

SHEET NUMBER

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PIPING - FIRST FLOOR PLAN
SCALE: 1/8"=1'-0"



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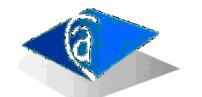


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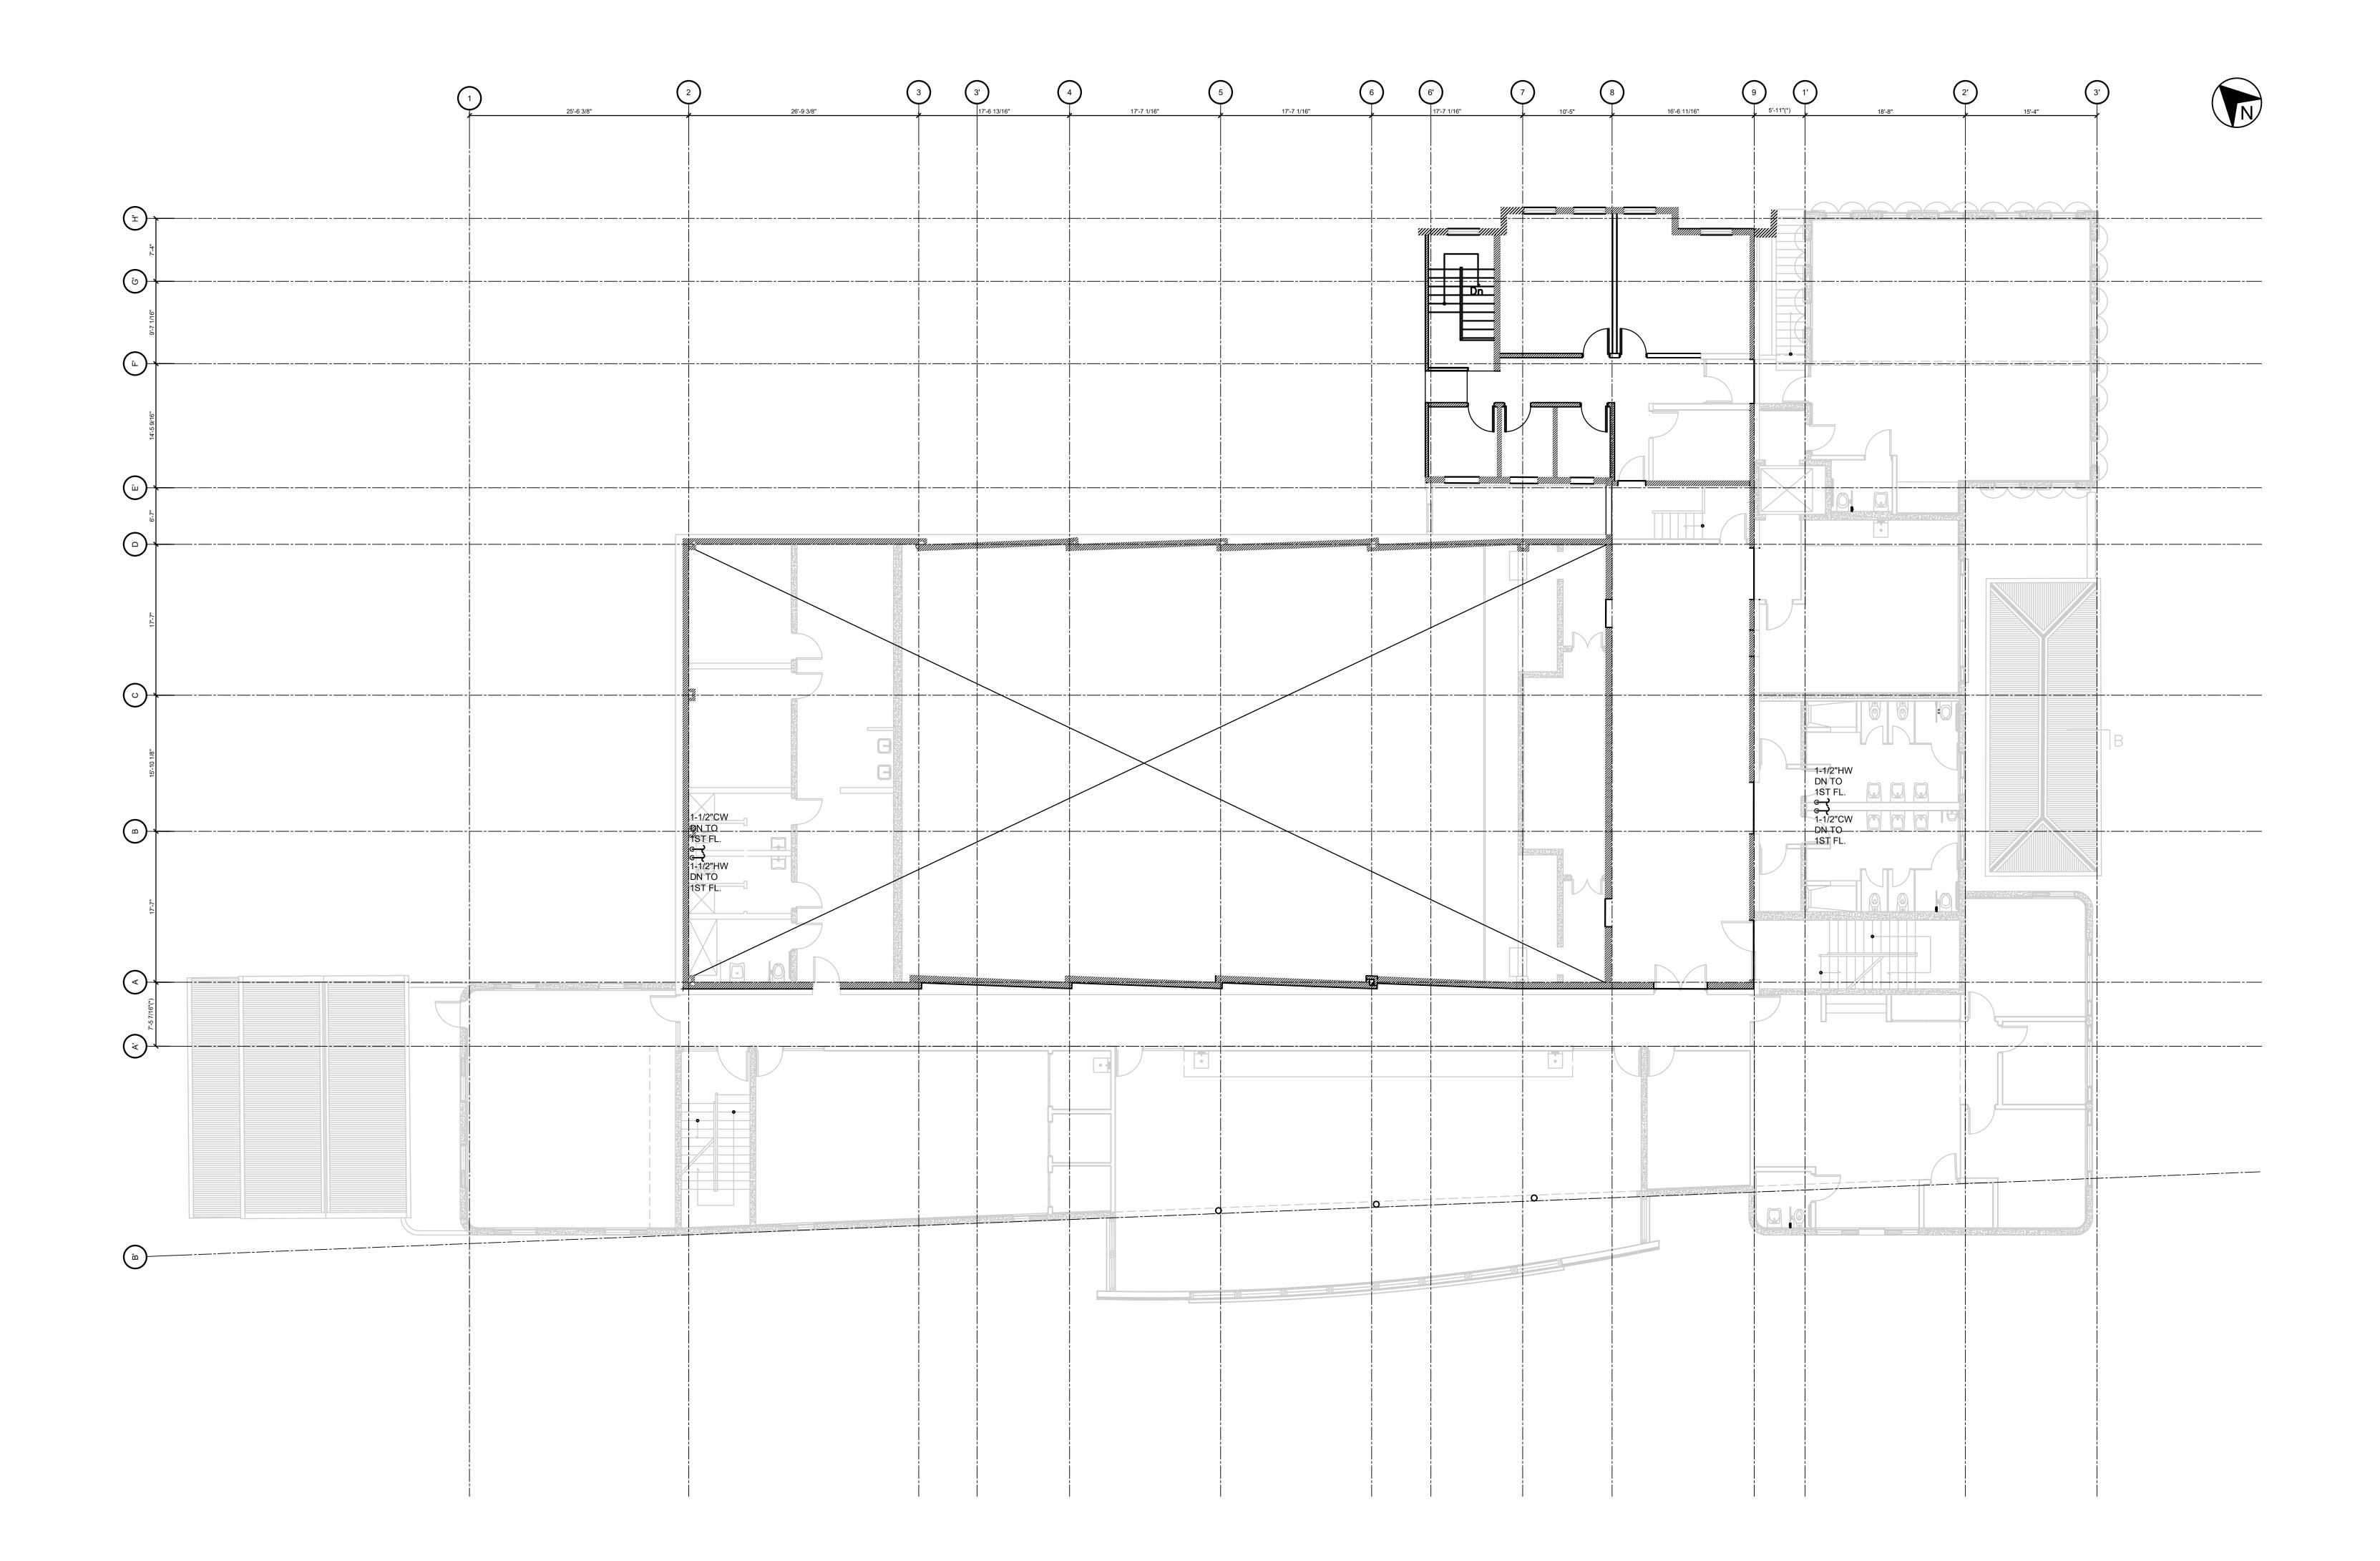
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PIPING- FIRST FLOOR PLAN

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PIPING - SECOND FLOOR PLAN
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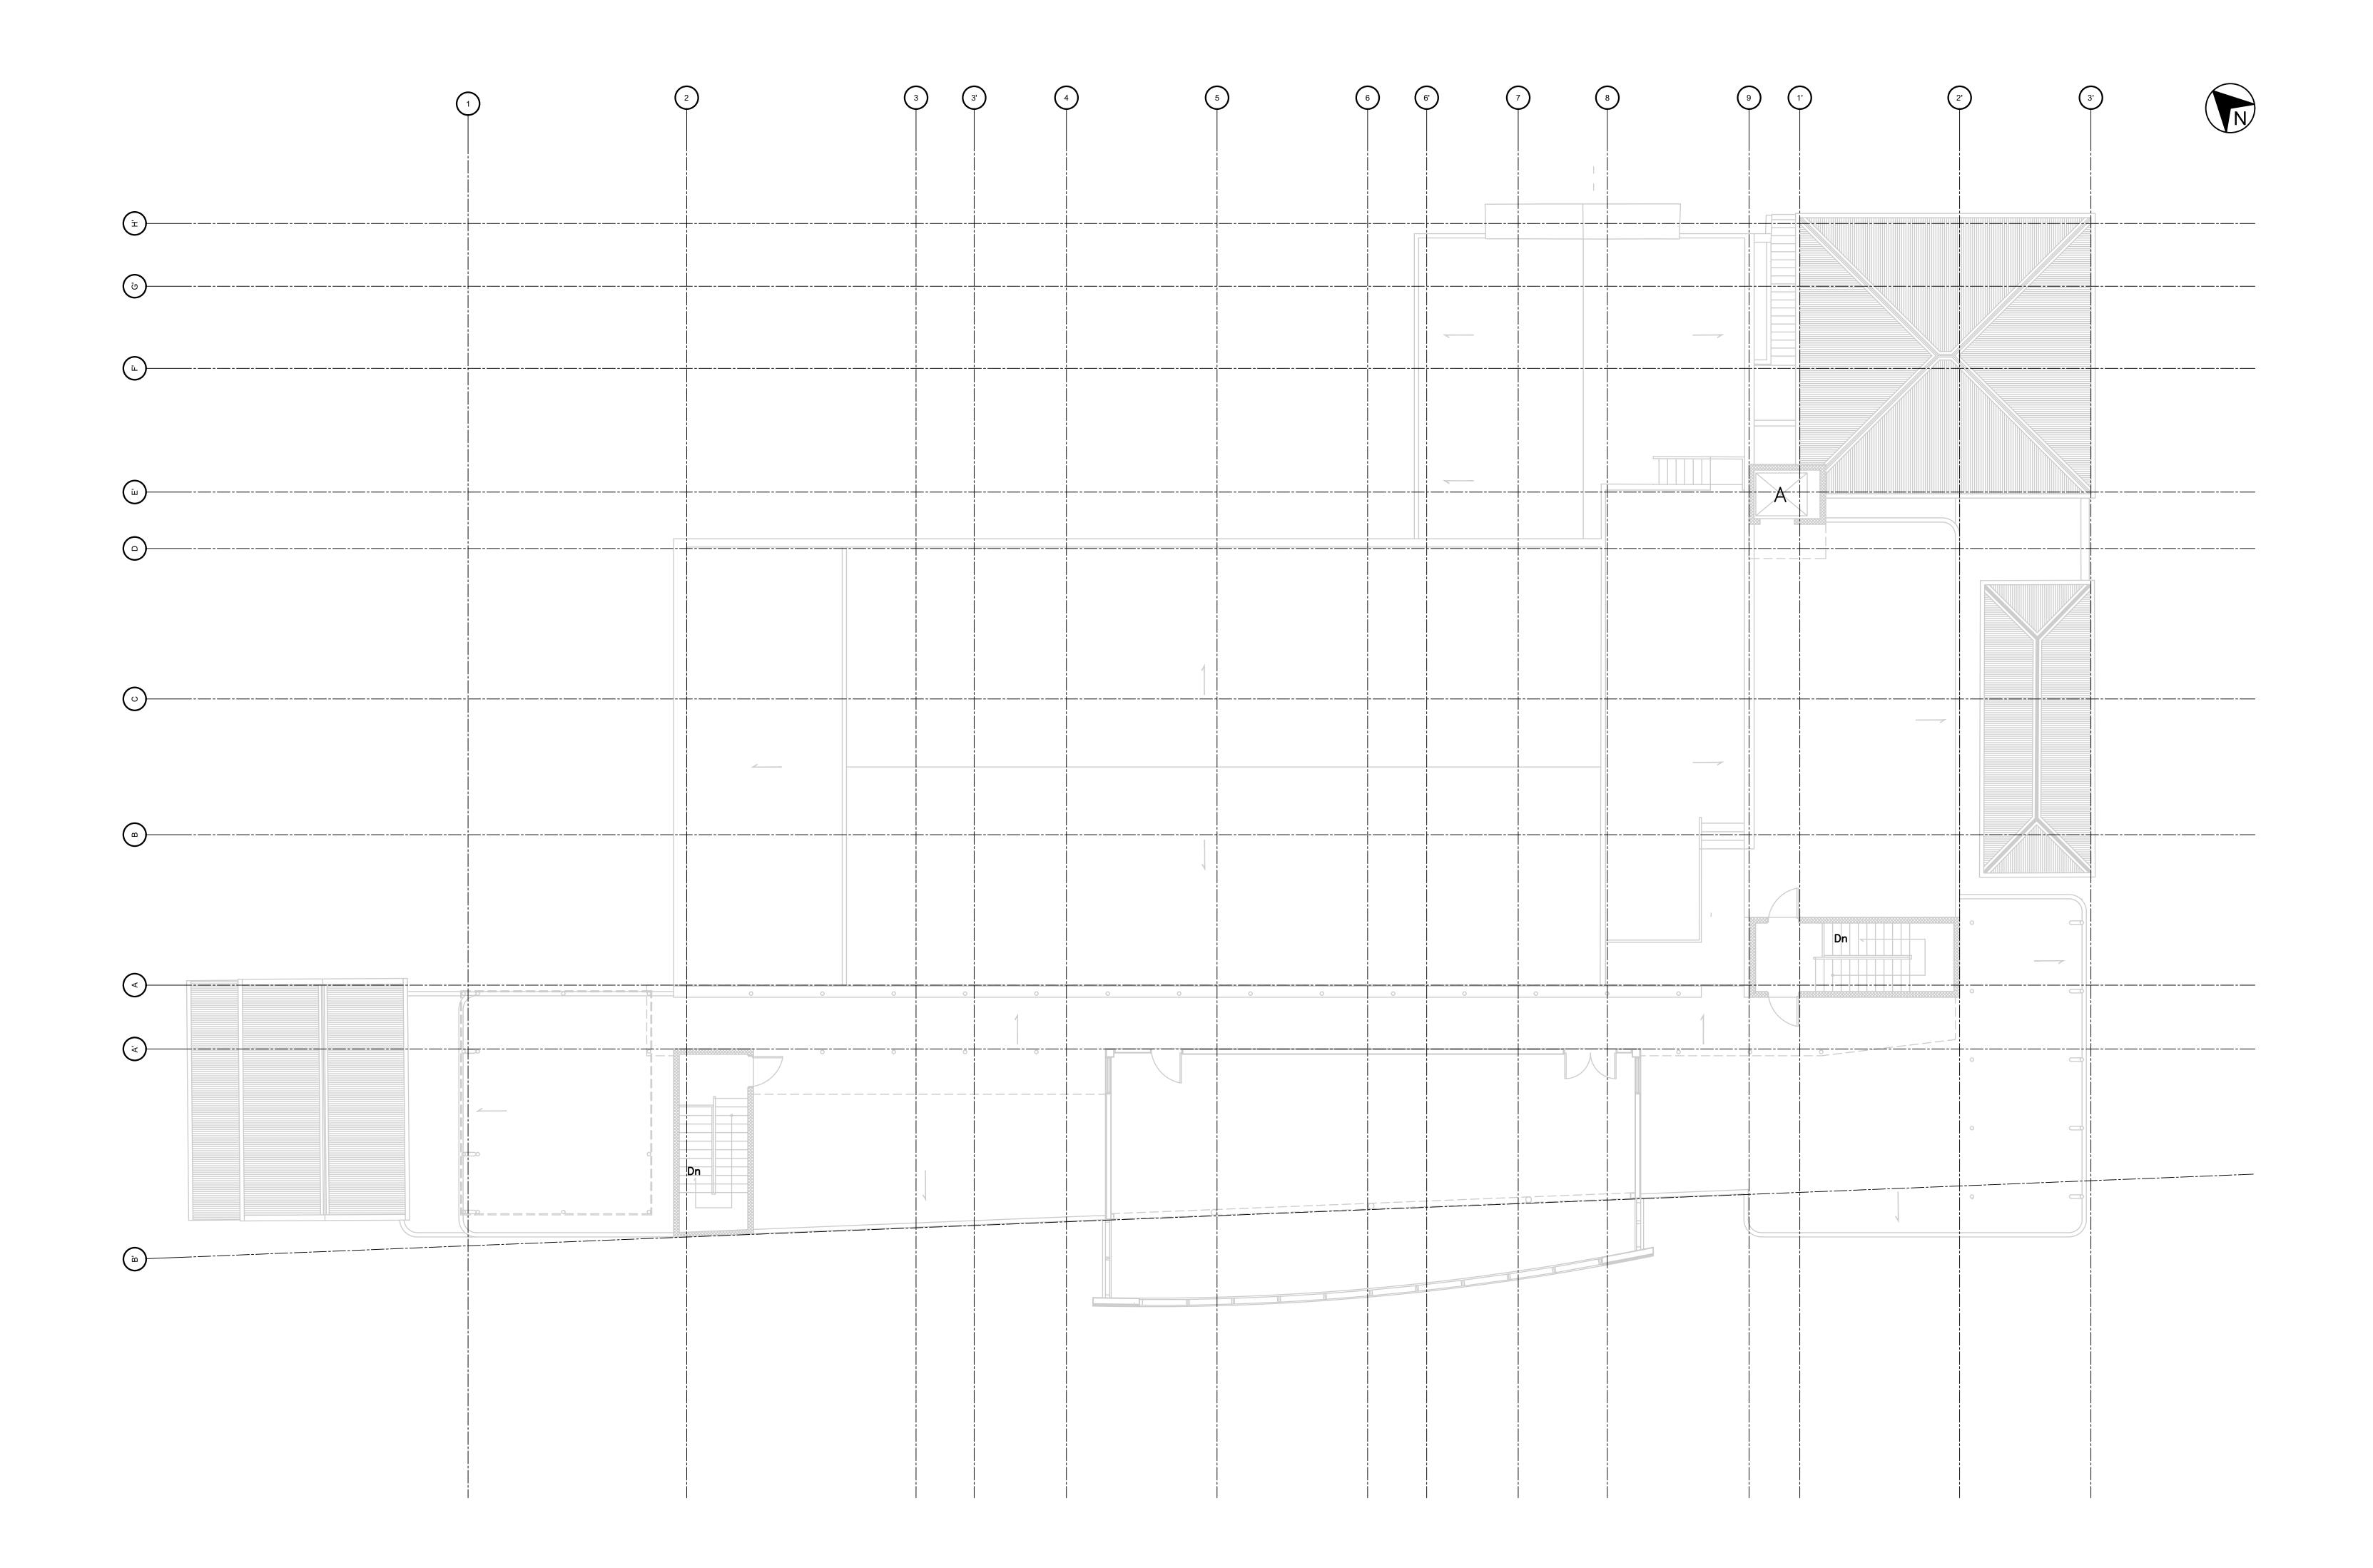
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PIPING - SECOND FLOOR PLAN

SHEET TITLE

M2-02



PIPING - THIRD FLOOR PLAN
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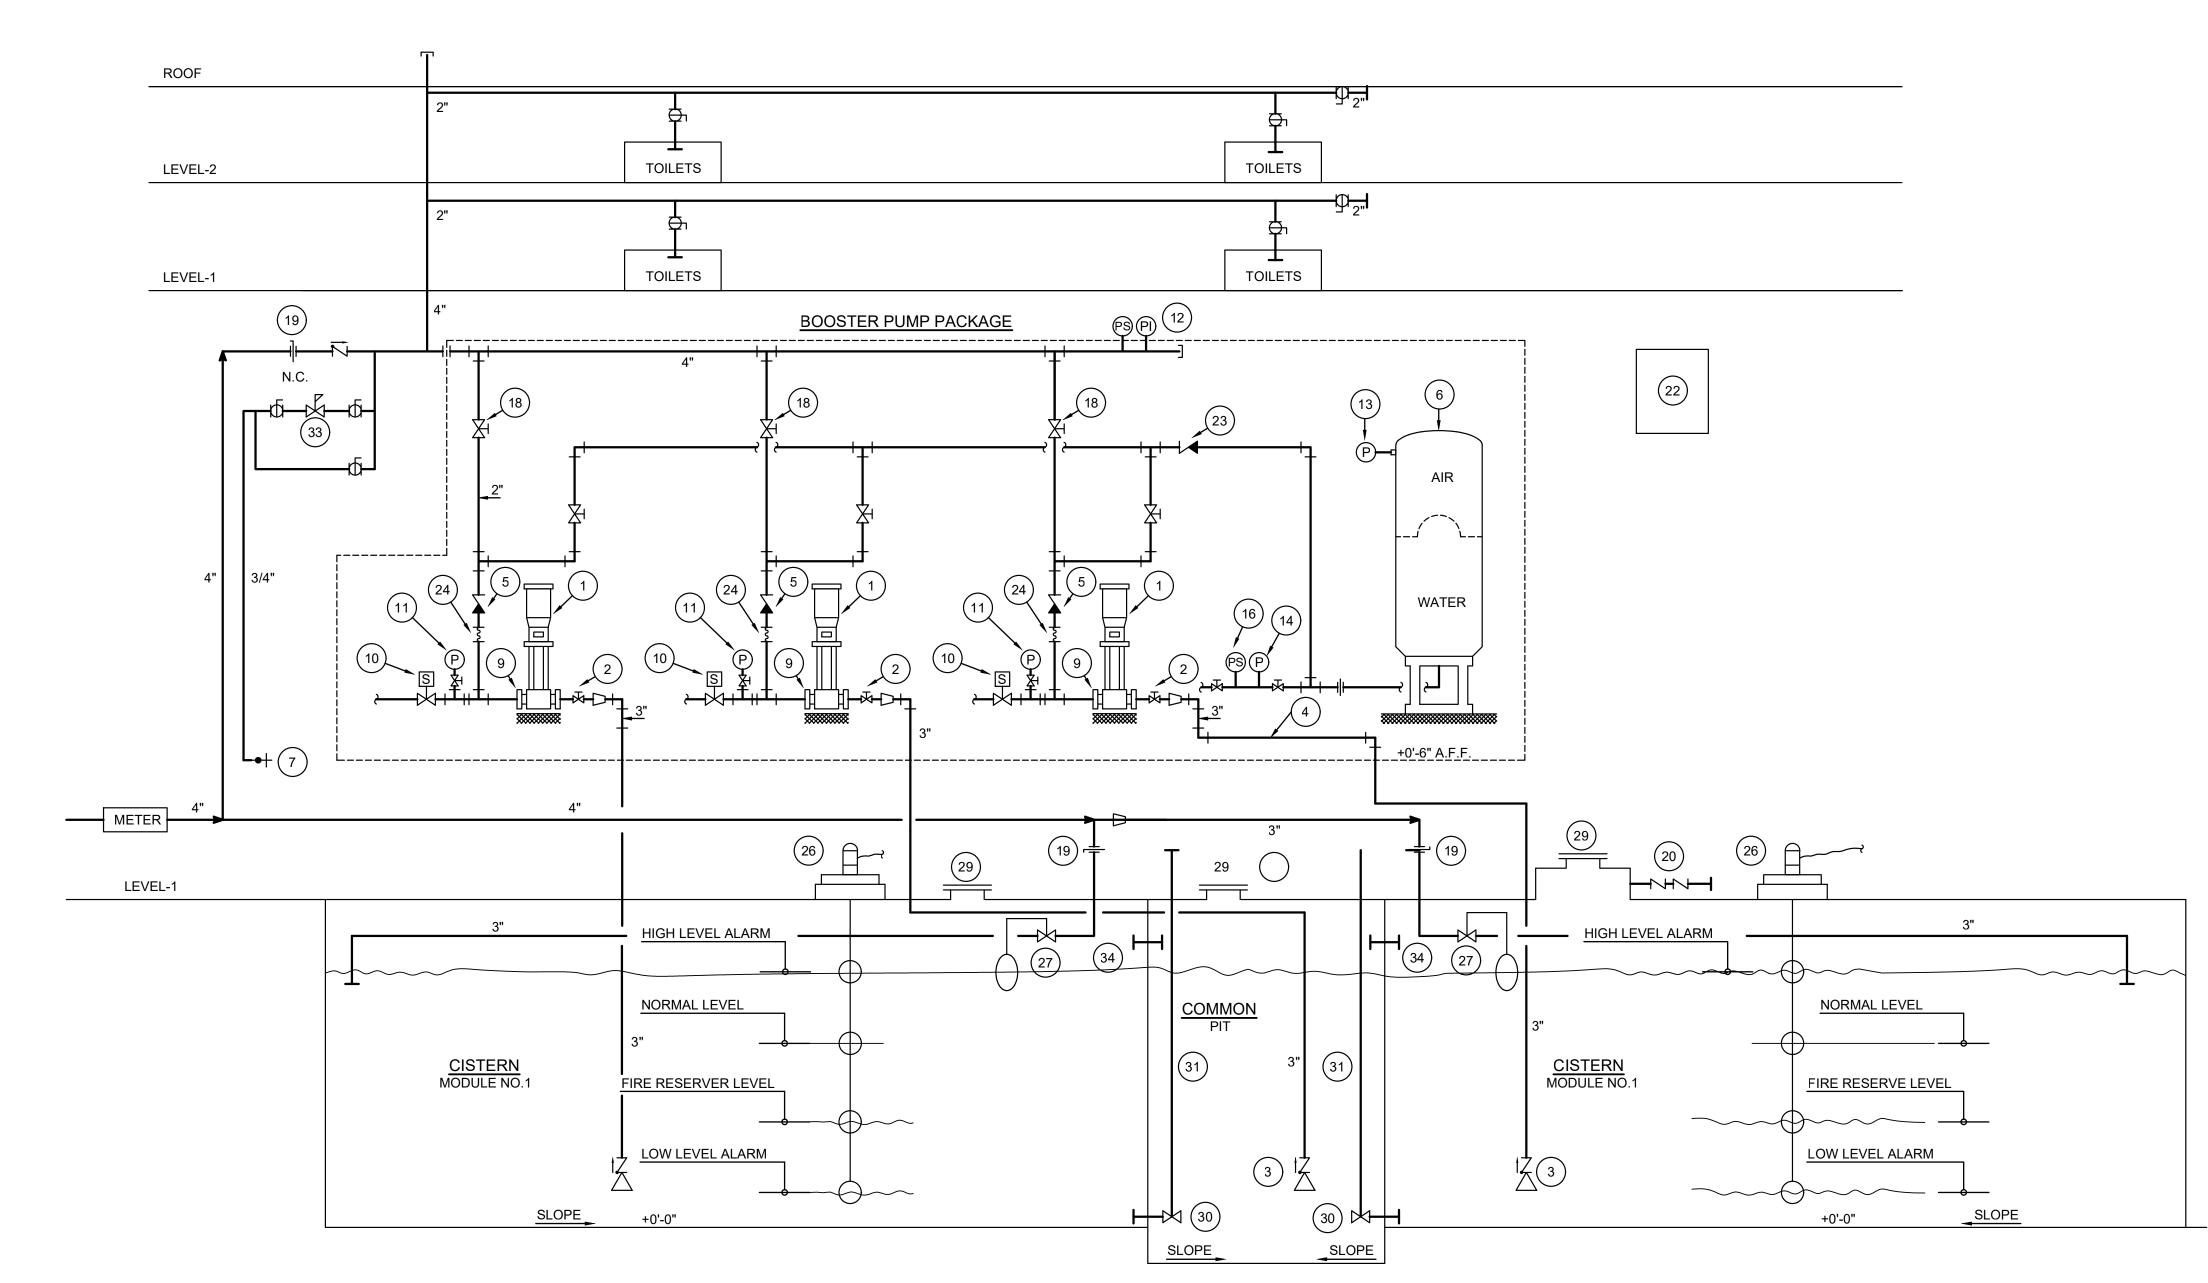
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PIPING - THIRD FLOOR PLAN

SHEET TITLE
M2-03



WATER PRESSURE BOOSTER SYSTEM SCHEMATIC

WATER PRESSURE BOOSTER SYSTEM SPECIFICATIONS

FURNISH AND INSTALL A PREFABRICATED IRONHEART HORIZONTAL THREE PUMP WATER PRESSURE BOOSTER SYSTEM AS DESIGNED AND MANUFACTURED BY SYNCROFLO, INC., NORCROSS, GEORGIA. THE SYSTEM SHALL BE CAPABLE OF AUTOMATICALLY PROVIDING A MINIMUM SYSTEM PRESSURE OF 70 PSIG WHILE SUPPLYING A FLOW RATE FROM 0 TO 100 GPM WITH A SUCTION LIFT OF 10 PSIG MINIMUM, 10 PSIG MAXIMUM. SYSTEM SHALL AUTOMATICALLY PROVIDE COMPLETE PUMP SHUTDOWN DURING LOW FLOW CONDITIONS WHILE MAINTAINING MINIMUM SYSTEM PRESSURE. THE SYSTEM SHALL AUTOMATICALLY STORE A MINIMUM OF 40 GALLONS OF USABLE WATER TO MAINTAIN SYSTEM PRESSURE WHEN OPERATING AT MINIMUM SUCTION PRESSURE.

THE PUMPS SHALL BE SYNCROFLO CONSTANT SPEED VERTICAL MULTI-STAGE DIFFUSER PUMPS WITH STAINLESS STEEL SHAFTS, STAINLESS STEEL IMPELLERS, AND A TUNGSTEN CARBIDE MECHANICAL SEAL. PUMPS SHALL BE MODEL 6LM6 RATED 35 GPM AT 162 FT (70 PSIG). TDH.

PUMPS SHALL BE DRIVEN BY 5 HP, 460 VOLT, 60 HERTZ, 3 PHASE, 3500 RPM, OPEN DRIP PROOF VERTICAL SOLID SHAFT MOTOR. EACH MOTOR SHALL MEET NEMA STANDARDS AND OPERATE WITHIN THE NAMEPLATE HORSE POWER AT ANY POINT ON THE PUMP CAPACITY HEAD CURVE. PRESSURE REGULATING VALVES

CONSTANT SYSTEM PRESSURE SHALL BE MAINTAINED BY PILOT OPERATED DIAPHRAGM TYPE, PRESSURE REGULATING VALVES ON EACH BUILDING RISER. VALVE BODY SHALL BE CAST IRON WITH EPOXY COATED COVER AND BRASS OR EPOXY COATED DISC GUIDE, DISC RETAINER, AND DIAPHRAGM WASHER. THE VALVE BODY SHALL BE SUITABLE FOR OPERATION AT MAXIMUM PUMP PRESSURE PLUS MAXIMUM SUCTION PRESSURE.

NEOPRENE FLEXIBLE CONNECTORS SHALL BE FURNISHED AT EACH PUMP DISCHARGE LINE.

0 TO 35 GPM PUMP NO. 1 ONLY SHALL RUN. 36 TO 70 GPM PUMPS NO. 1 AND NO. 2 SHALL RUN TOGETHER. 71 TO 105 GPM PUMPS NO. 1, 2 & 3 SHALL RUN TOGETHER.

THE LAG PUMPS SHALL BE SEQUENCED ON AND OFF BY FACTORY SET, DIRECT SENSING, PRESSURE SWITCHES.

LEAD PUMP SHUTDOWN CONTROLS

PROVIDE A FACTORY PRECHARGED, ASME CODE AND NB STAMPED, 50 GALLON 150 PSIG RATED SYNCROFLO HYDROCUMULATOR TANK. CONSTRUCTION FEATURES SHALL INCLUDE AN ASME RELIEF VALVE, AN AIR FILL VALVE, AN AIR PRESSURE GAUGE, A DRAIN VALVE, AND A REPLACEABLE FLEXIBLE MEMBRANE TO SEPARATE AIR AND WATER. NO WATER SHALL COME IN CONTACT WITH THE METAL WALLS OF THE TANK. IN ADDITION THE HYDROCUMULATOR TANK SHALL BE BOTTOM FED AND CAPABLE OF 100% DRAW DOWN. TANK SHALL SHIP PRECHARGED TO THE PROPER DESIGN CONDITIONS. THE TANK SHALL BE CAPABLE OF STORING A MINIMUM OF 40 GALLONS OF USABLE WATER WITH THE SCHEDULED PUMP AND DESIGN CONDITIONS.

PROVIDE A PRESSURE SWITCH, A MAXI-STORE FLOW SWITCH, AND A TIME DELAY RELAY TO AUTOMATICALLY CONTROL LEAD PUMP ON-OFF OPERATION. THESE CONTROLS SHALL OPERATE IN SUCH A WAY AS TO PREVENT HIGH FLOW RATE SHUTDOWNS AND LEAD PUMP SHORT CYCLING WHILE MAXIMIZING THE AMOUNT OF STORED WATER AVAILABLE FROM THE HYDROCUMULATOR

IN ADDITION, PROVIDE A SPRING LOADED, NON-SLAM SILENT CHECK VALVE ON EACH PUMP

DISCHARGE LINE WITH 1 1/4" FEEDLINE PIPING AND ISOLATION VALVE (S).

THE TANK SHALL BE LOCATED WITH THE PUMPS AND THE FEEDLINE CONNECTION (S) FROM THE TANK SHALL BE BETWEEN THE PUMP CHECK VALVE (S) AND PRESSURE REGULATING VALVE (S) TO ASSURE CONSTANT SYSTEM PRESSURE AND PREVENT LEAKS BACK TO SUCTION.

POWER AND CONTROL PANEL

FURNISH A SINGLE ENCLOSURE SYNCROFLO POWER AND CONTROL PANEL NEMA 1. ENCLOSURE SHALL BE STEEL AND FURNISHED WITH AN INDUSTRIAL GRADE ENAMEL. IT SHALL HOUSE ALL CONTROL COMPONENTS AND INCLUDE 115 V CONTROL TRANSFORMER WITH CONTROL POWER SWITCH, INDICATING LIGHTS, MANUAL ALTERNATOR, AUDIO-VISUAL ALARM SYSTEM, AND OTHER NECESSARY CONTROLS. INCLUDE FOR EACH PUMP A FUSED DISCONNECT SWITCH WITH EXTERNAL OPERATING HANDLE, A MAGNETIC STARTER WITH 3-LEG OVERLOAD PROTECTION, A RUNNING LIGHT, AND MULTIPLE POSITION SELECTOR SWITCH. ALL OF THE ABOVE SHALL BE FACTORY INTERNALLY PREWIRED AND TESTED IN ACCORDANCE WITH THE PROVISIONS OF THE NATIONAL ELECTRICAL CODE. ALL CONTROL WIRES SHALL BE INDIVIDUALLY NUMBERED AND EACH COMPONENT SHALL BE LABELED ACCORDINGLY. ALL INTERNAL WIRING SHALL BE COPPER STRANDED, A.W.G. WITH A MINIMUM INSULATION OF 90 DEGREES C. THE COMPLETE ASSEMBLY

INSTRUMENTATION AND EMERGENCY CONTROLS

SHALL HAVE THE UL LISTING MARK FOR INDUSTRIAL CONTROL PANELS.

EACH PUMP SHALL HAVE ANTI-VIBRATION PADS, A TEMPERATURE PROBE, AND AN ELECTRIC PURGE VALVE. INCLUDE INDIVIDUAL 4 1/2" ASA GRADE A PRESSURE GAUGES FOR INDICATING EACH PUMP SYSTEM, AND SUCTION PRESSURE. INCLUDE PRESSURE SWITCHES FOR ABNORMALLY LOW SYSTEM PRESSURE TO ACTIVATE THE MANUAL RESET ALARM SYSTEM. ALL PRESSURE SWITCHES, AS WELL AS THE SYSTEM AND SUCTION PRESSURE GAUGES, SHALL BE CONTROL panel mounted.

THE SYNCROFLO WATER PRESSURE BOOSTER SYSTEM SHALL BE GUARANTEED IN WRITING BY THE MANUFACTURER FOR A PERIOD OF ONE YEAR FROM DATE OF SHIPMENT AGAINST DEFECTS IN DESIGN, MATERIALS, OR CONSTRUCTION.

THE SERVICE OF A FACTORY TRAINED REPRESENTATIVE SHALL BE MADE AVAILABLE ON THE JOBSITE TO CHECK INSTALLATION AND START-UP AND INSTRUCT OPERATING PERSONNEL.

THE SUBMITTAL DATA FOR THE PUMPING SYSTEM SHALL INCLUDE, BUT NOT LIMITED TO: PUMP CURVES, INDIVIDUAL COMPUTER DATA SHEETS, SYSTEM DRAWINGS, AND COMPLETE DESCRIPTION

OF CONTROL PANEL, WITH WIRING DIAGRAM, SEQUENCING DATA, INSTRUMENTATION AND ALARMS.

THE SYNCROFLO PUMPING SYSTEM SHALL BE GUARANTEED IN WRITING BY THE MANUFACTURER

FOR A PERIOD OF ONE YEAR FROM DATE OF SHIPMENT AGAINST DEFECT IN DESIGN, MATERIAL,

OR CONSTRUCTION.

THE SERVICE OF A FACTORY TRAINED REPRESENTATIVE SHALL BE MADE AVAILABLE ON THE JOBSITE TO CHECK INSTALLATION AND START-UP AND INSTRUCT OPERATING PERSONNEL.

INSTRUCTION MANUALS

FURNISH TO OWNER FOUR (4) SETS OF INSTALLATION, OPERATION AND MAINTENANCE MANUALS. SPARE PARTS AND MAINTENANCE SERVICES

EQUIPMENT WHICH IS NOT PROPERLY REPRESENTED IN PUERTO RICO AND BACKED UP WITH SPARE PARTS AND A GOOD SERVICE ORGANIZATION SHALL NOT BE ACCEPTABLE.

(2) WARRICK ELECTRODE CONTROLS FOR LOW LEVEL AND HIGH LEVEL ALARM, WITH PROBE HOLDER, SUSPENSION TIPS AND SUSPENSION WIRE.

(1) 4" SUCTION STRAINER AND FOOT VALVE.

(1) 2" FLOAT VALVE EPOXY COATED.

(1) NEMA 12 LOW AND HIGH LEVEL ALARM PANEL.

BOOSTER PUMP SYSTEM EQUIPMENT						
LEGEND	DESCRIPTION	REMARK	LEGEND	DESCRIPTION	REMARK	
1	VERTICAL MULTISTAGE DIFFUSER PUMP MODEL 6LM6 WITH 15 HP 3 PH/60 HZ/460 V MOTOR	PART OF EQUIPMENT	19	BUTTERFLY VALVE	PART OF EQUIPMENT	
2	2" SUCTION VALVE	PART OF EQUIPMENT	20	4" OVER FLOW W/INSECT SCREEN	CONTRACTOR	
3	4" SUCTION STRAINER AND FOOT VALVE	PART OF EQUIPMENT	21)	6"Ø VENT W/INSECT SCREEN (PVC)	CONTRACTOR	
4	SUCTION LINE 3"	PART OF EQUIPMENT	22	POWER AND CONTROL PANEL	PART OF EQUIPMENT	
5	NON-SLAM CHECK VALVE	PART OF EQUIPMENT	23)	ORIFICE CHECK VALVE 1 1/2"	PART OF EQUIPMENT	
6	MOD. 170 HYDROCUMULATOR TANK	PART OF EQUIPMENT	24	NEOPRENE FLEXIBLE CONNECTOR 3"	PART OF EQUIPMENT	
7	3/4" HOSE BIBB WITH BACKFLOW PREVENTER	CONTRACTOR	25)	MAXI-STORE FLOW SWITCH	PART OF EQUIPMEN	
8	MAIN DOMESTIC HEADER 4"	PART OF EQUIPMENT	26	WATER LEVEL CONTROL	PART OF EQUIPMEN	
9	TEMPERATURE PROBE	PART OF EQUIPMENT	27)	3" FLOAT VALVE	PART OF EQUIPMENT	
10	PURGE VALVE 3/8"	PART OF EQUIPMENT	28	GATE SHUT/OFF VALVE	CONTRACTOR	
11)	PRESSURE GAUGE PUMP DISCHARGE 0-300 PSI	PART OF EQUIPMENT	29	30"x30" WATERTIGHT ACCESS DOOR	CONTRACTOR	
12	PRESSURE GAUGE SYSTEM 0-300 PSI	PART OF EQUIPMENT	30	24"x24" SLUICE GATE VALVE AS MANUF. BY RODNEY HUNT	CONTRACTOR	
13)	PRESSURE GAUGE HYDROCUMULATOR 0-300 PSI	PART OF EQUIPMENT	31)	OPERATING STEM WITH FLOORSTAND AND STEMGUIDE	CONTRACTOR	
14)	PRESSURE GAUGE, FEET LINE 0-300 PSI	PART OF EQUIPMENT	32	BACKFLOW PREVENTER	CONTRACTOR	
15)	3" SWING CHECK VALVES	CONTRACTOR	33	PRESSURE REDUCING VALVE	CONTRACTOR	
16	PRESSURE SWITCH (LEAD PUMP)	PART OF EQUIPMENT	34)	4"Ø PIPE SLEEVE (VENT.)		
17)	PRESSURE SWITCH (LAG PUMP)	PART OF EQUIPMENT				
(18)	DISCHARGE VALVE 2"	PART OF EQUIPMENT				



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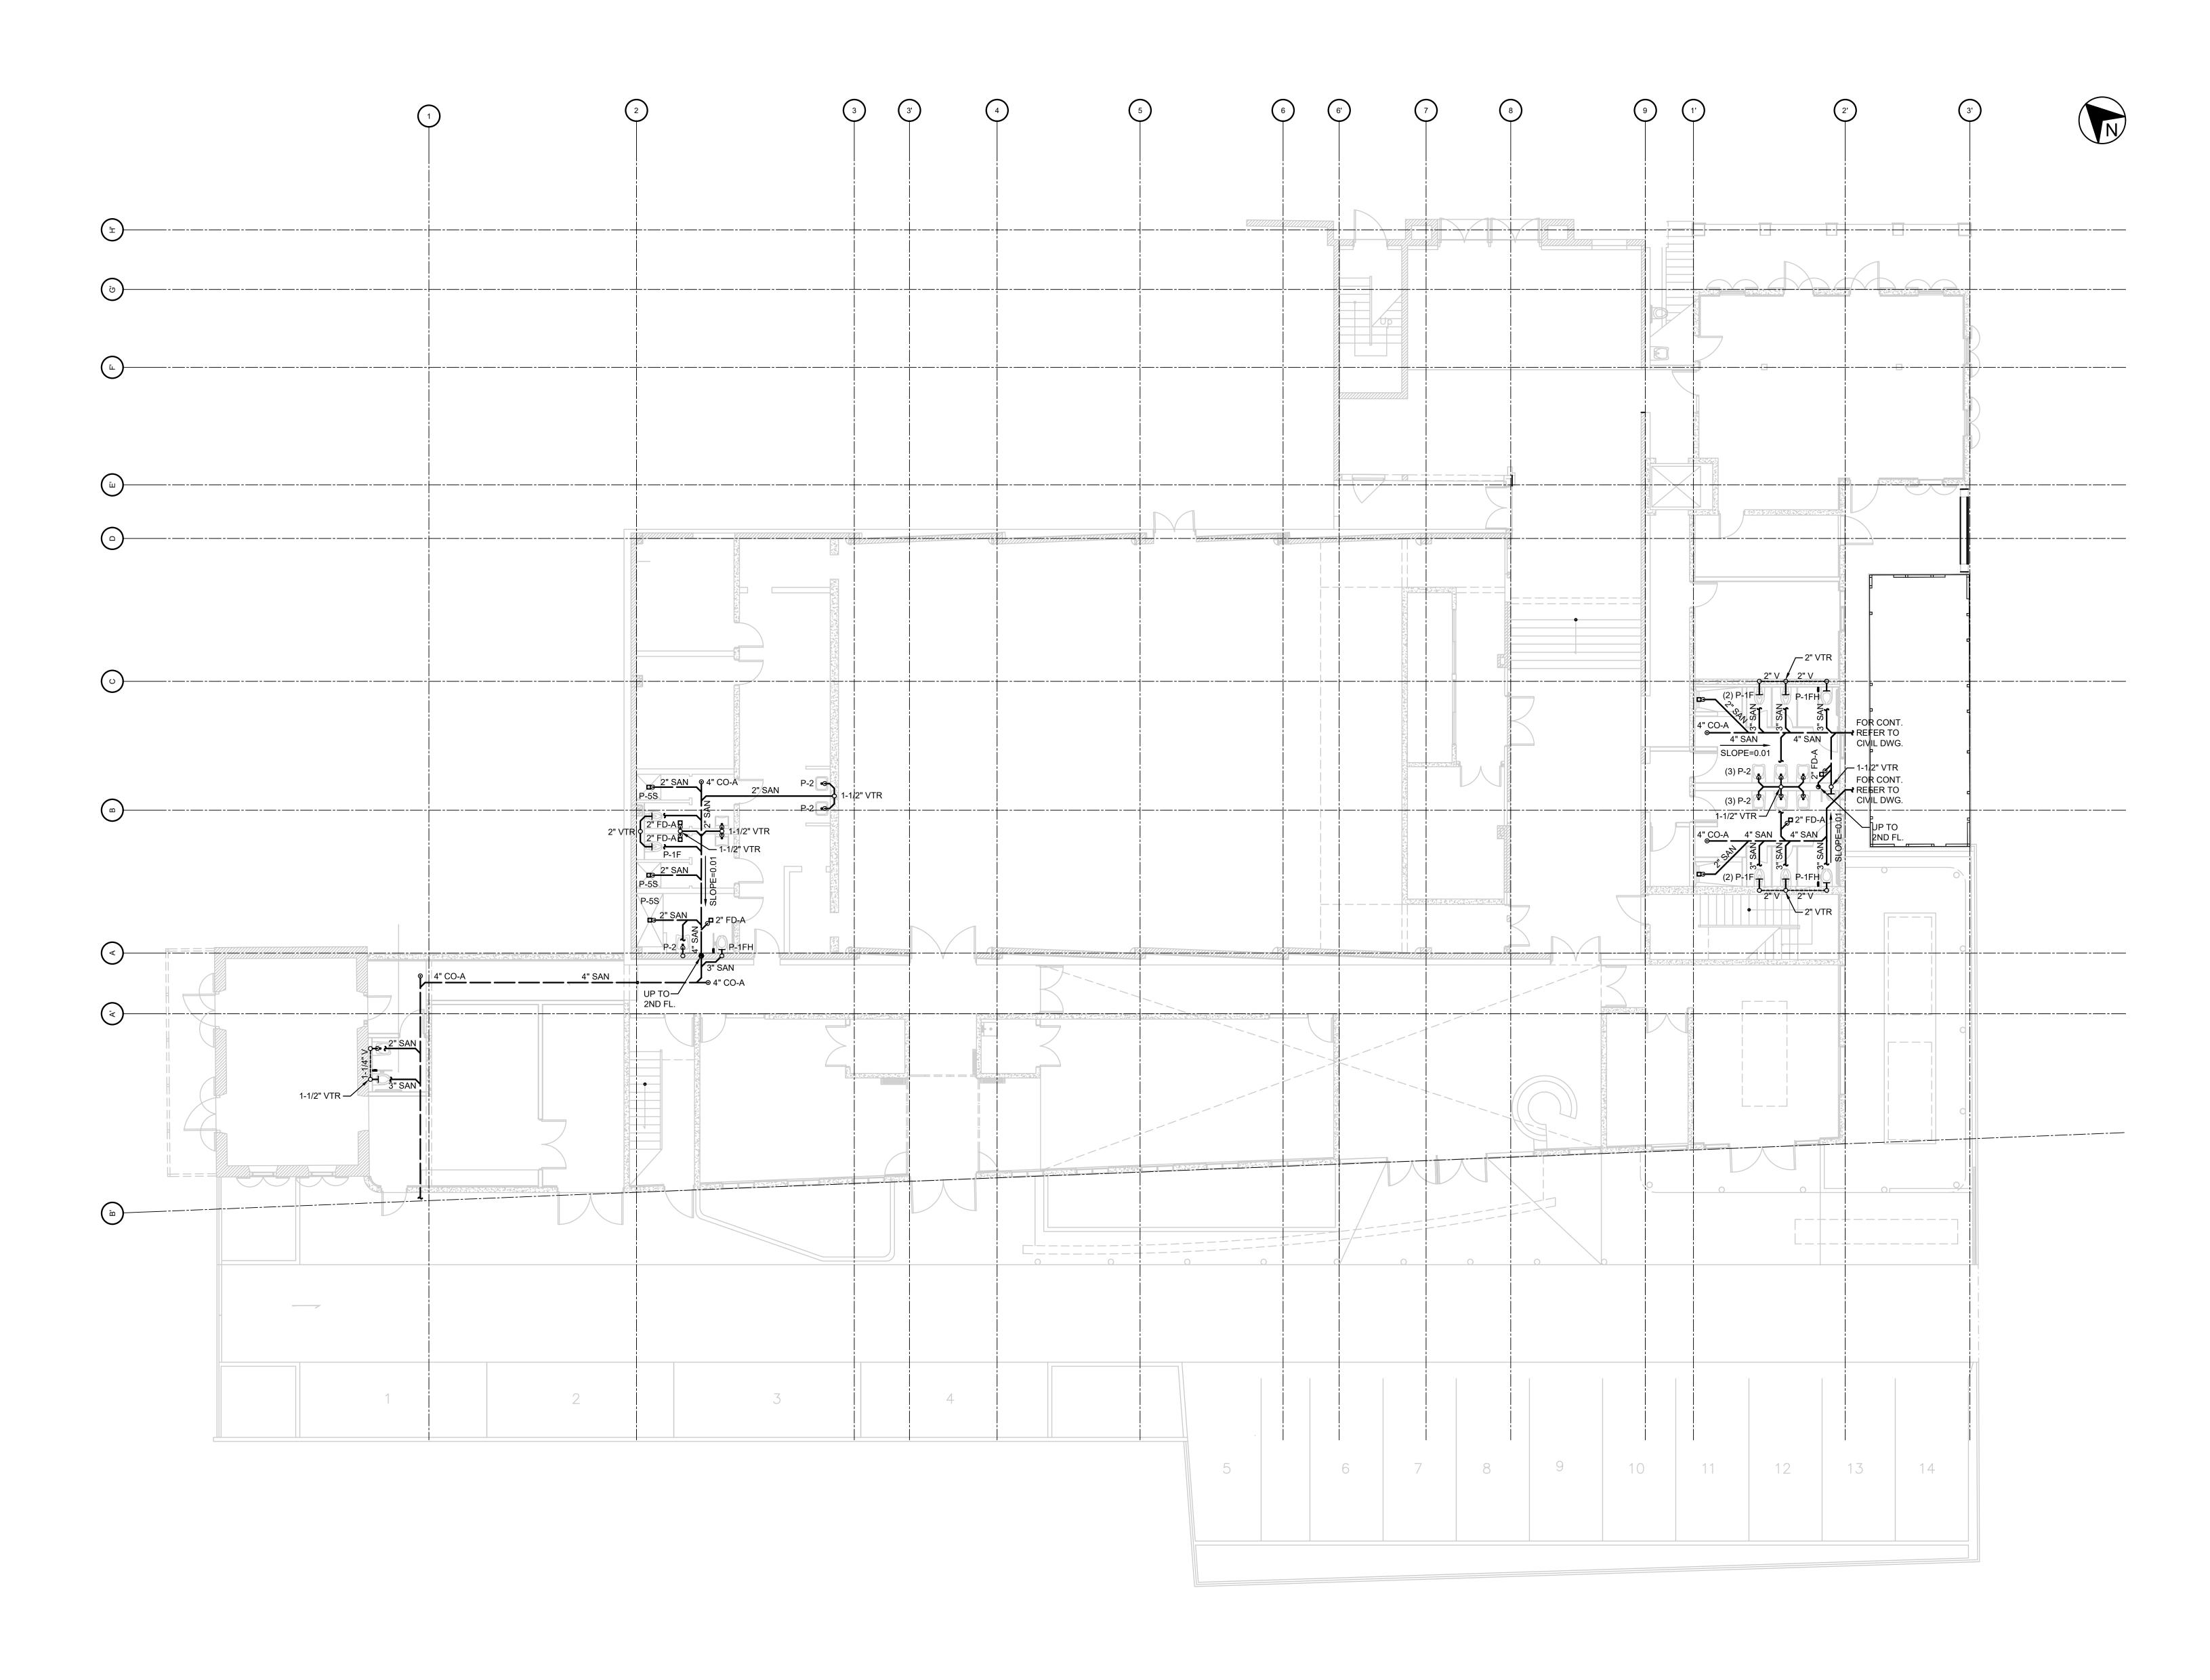
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POTABLE WATER SYSTEM



PLUMBING - FIRST FLOOR PLAN
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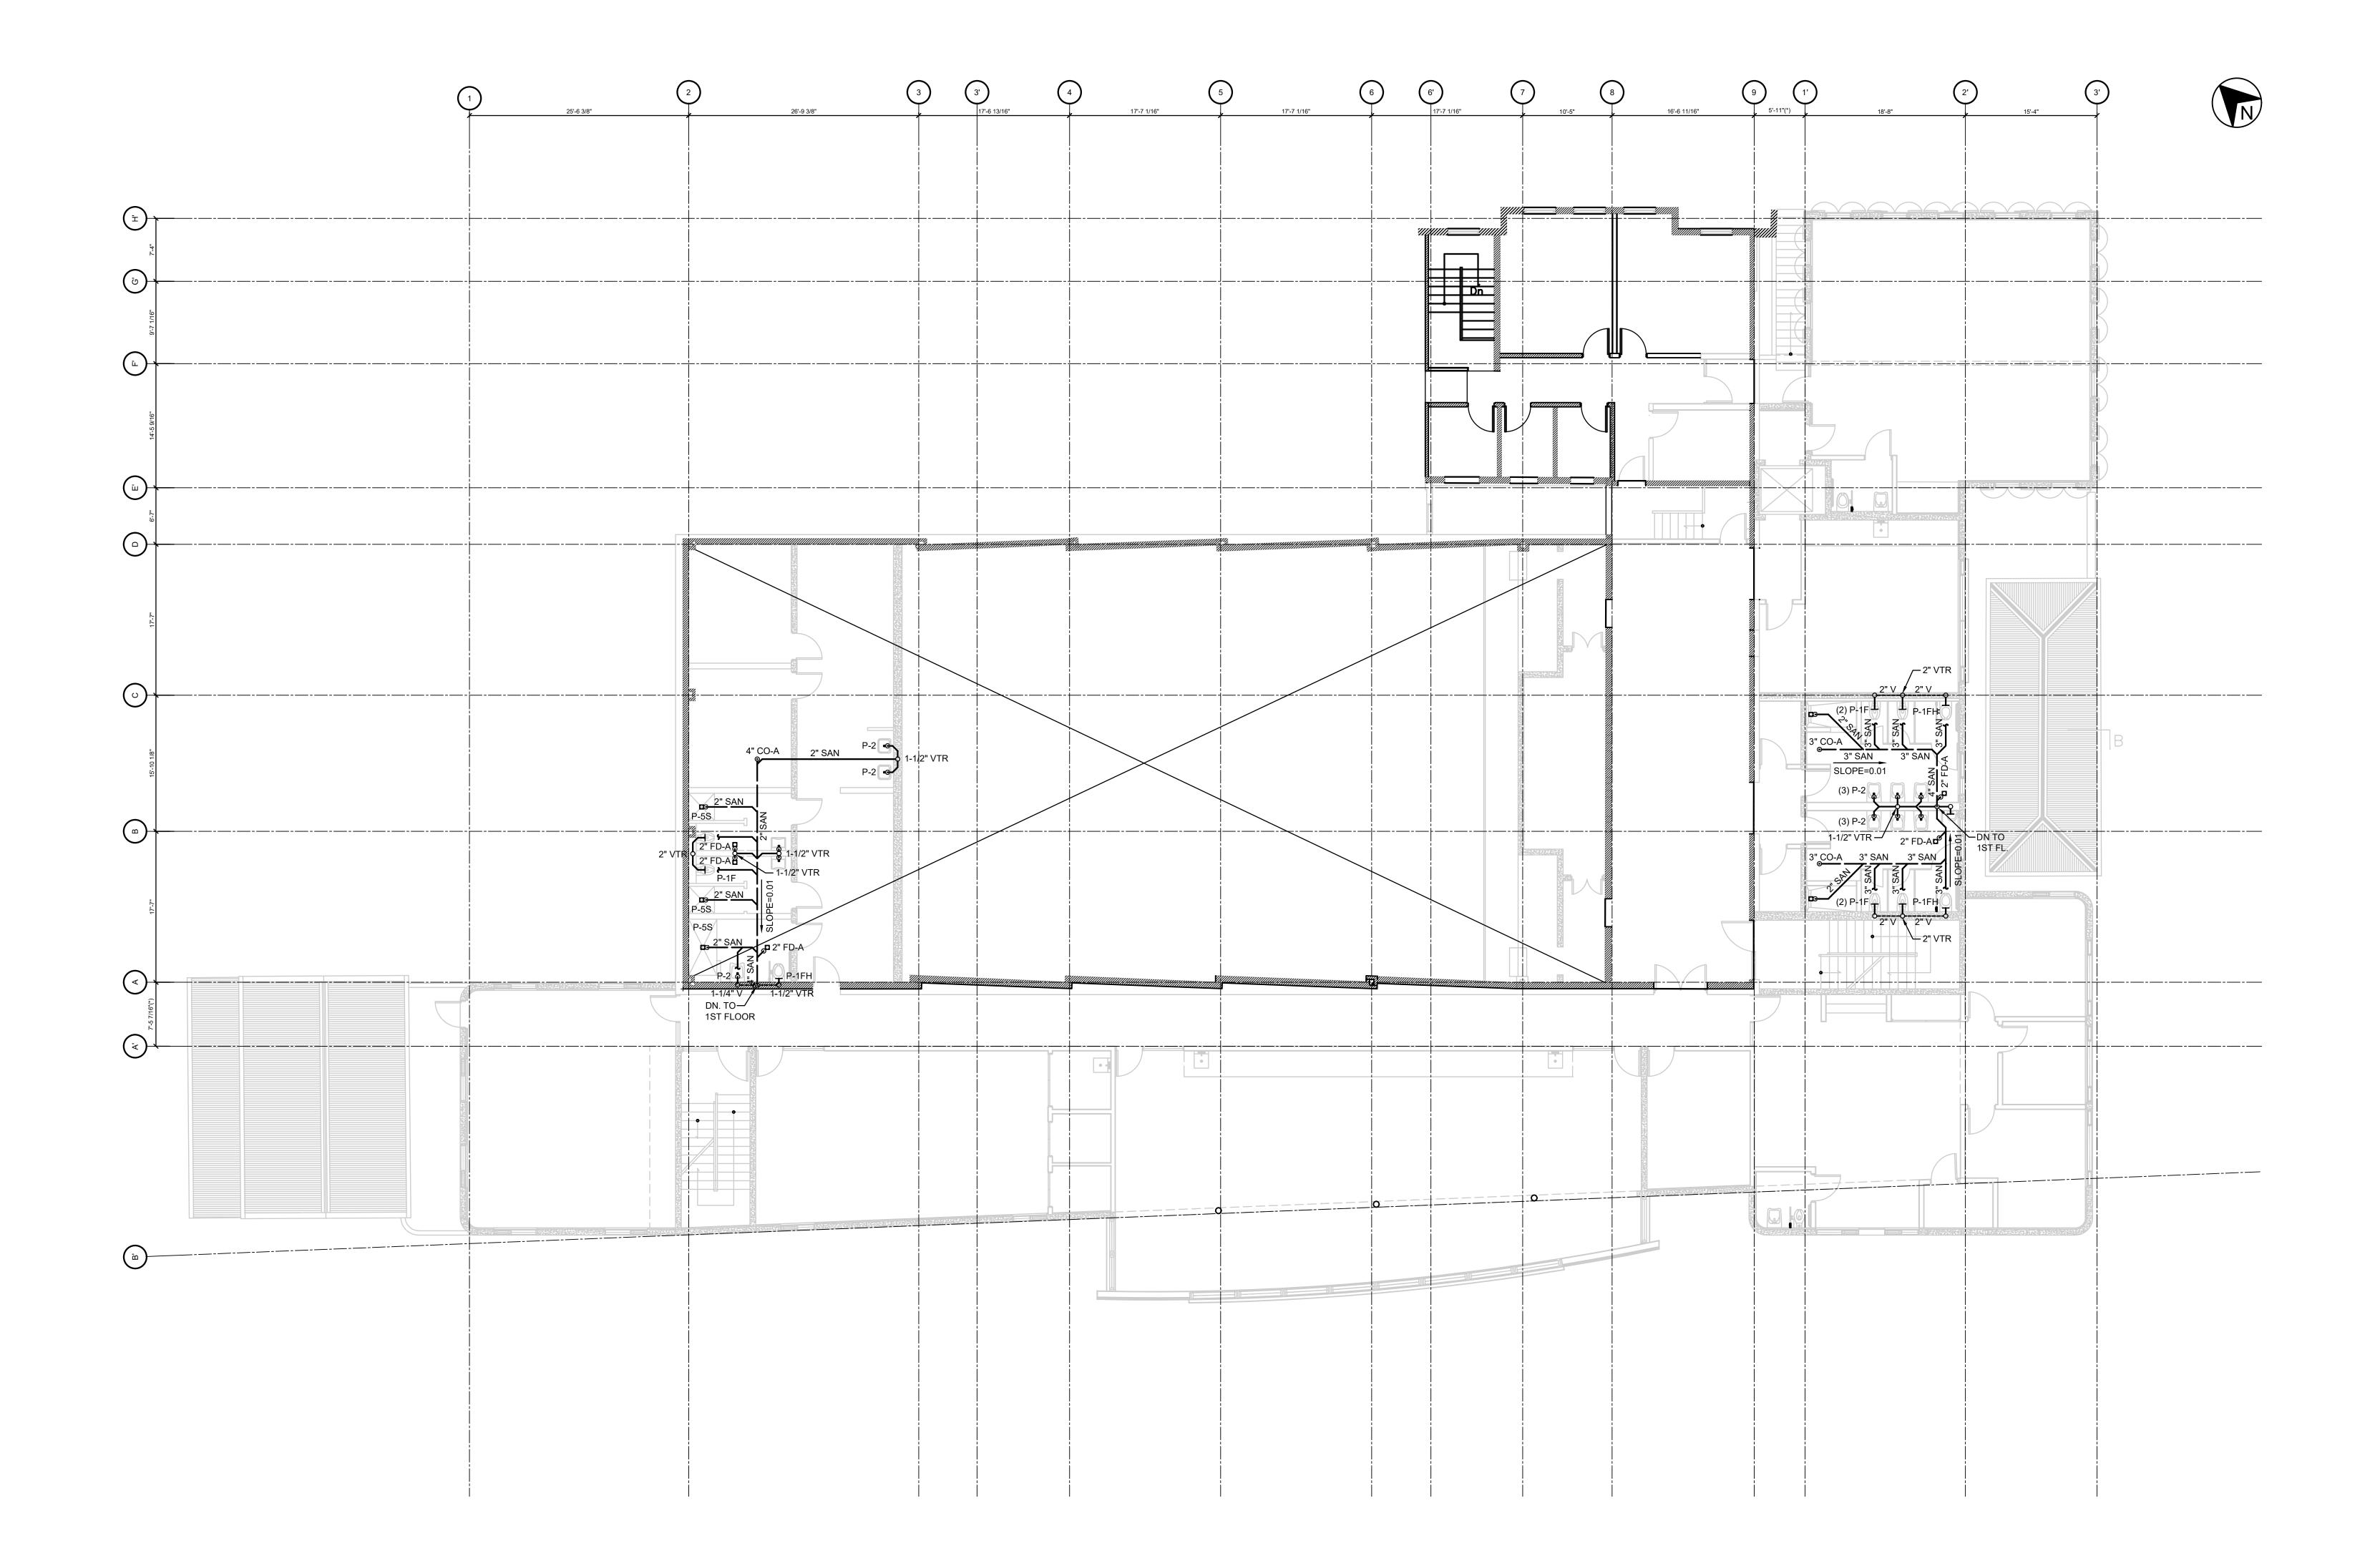
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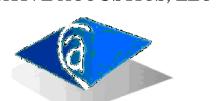
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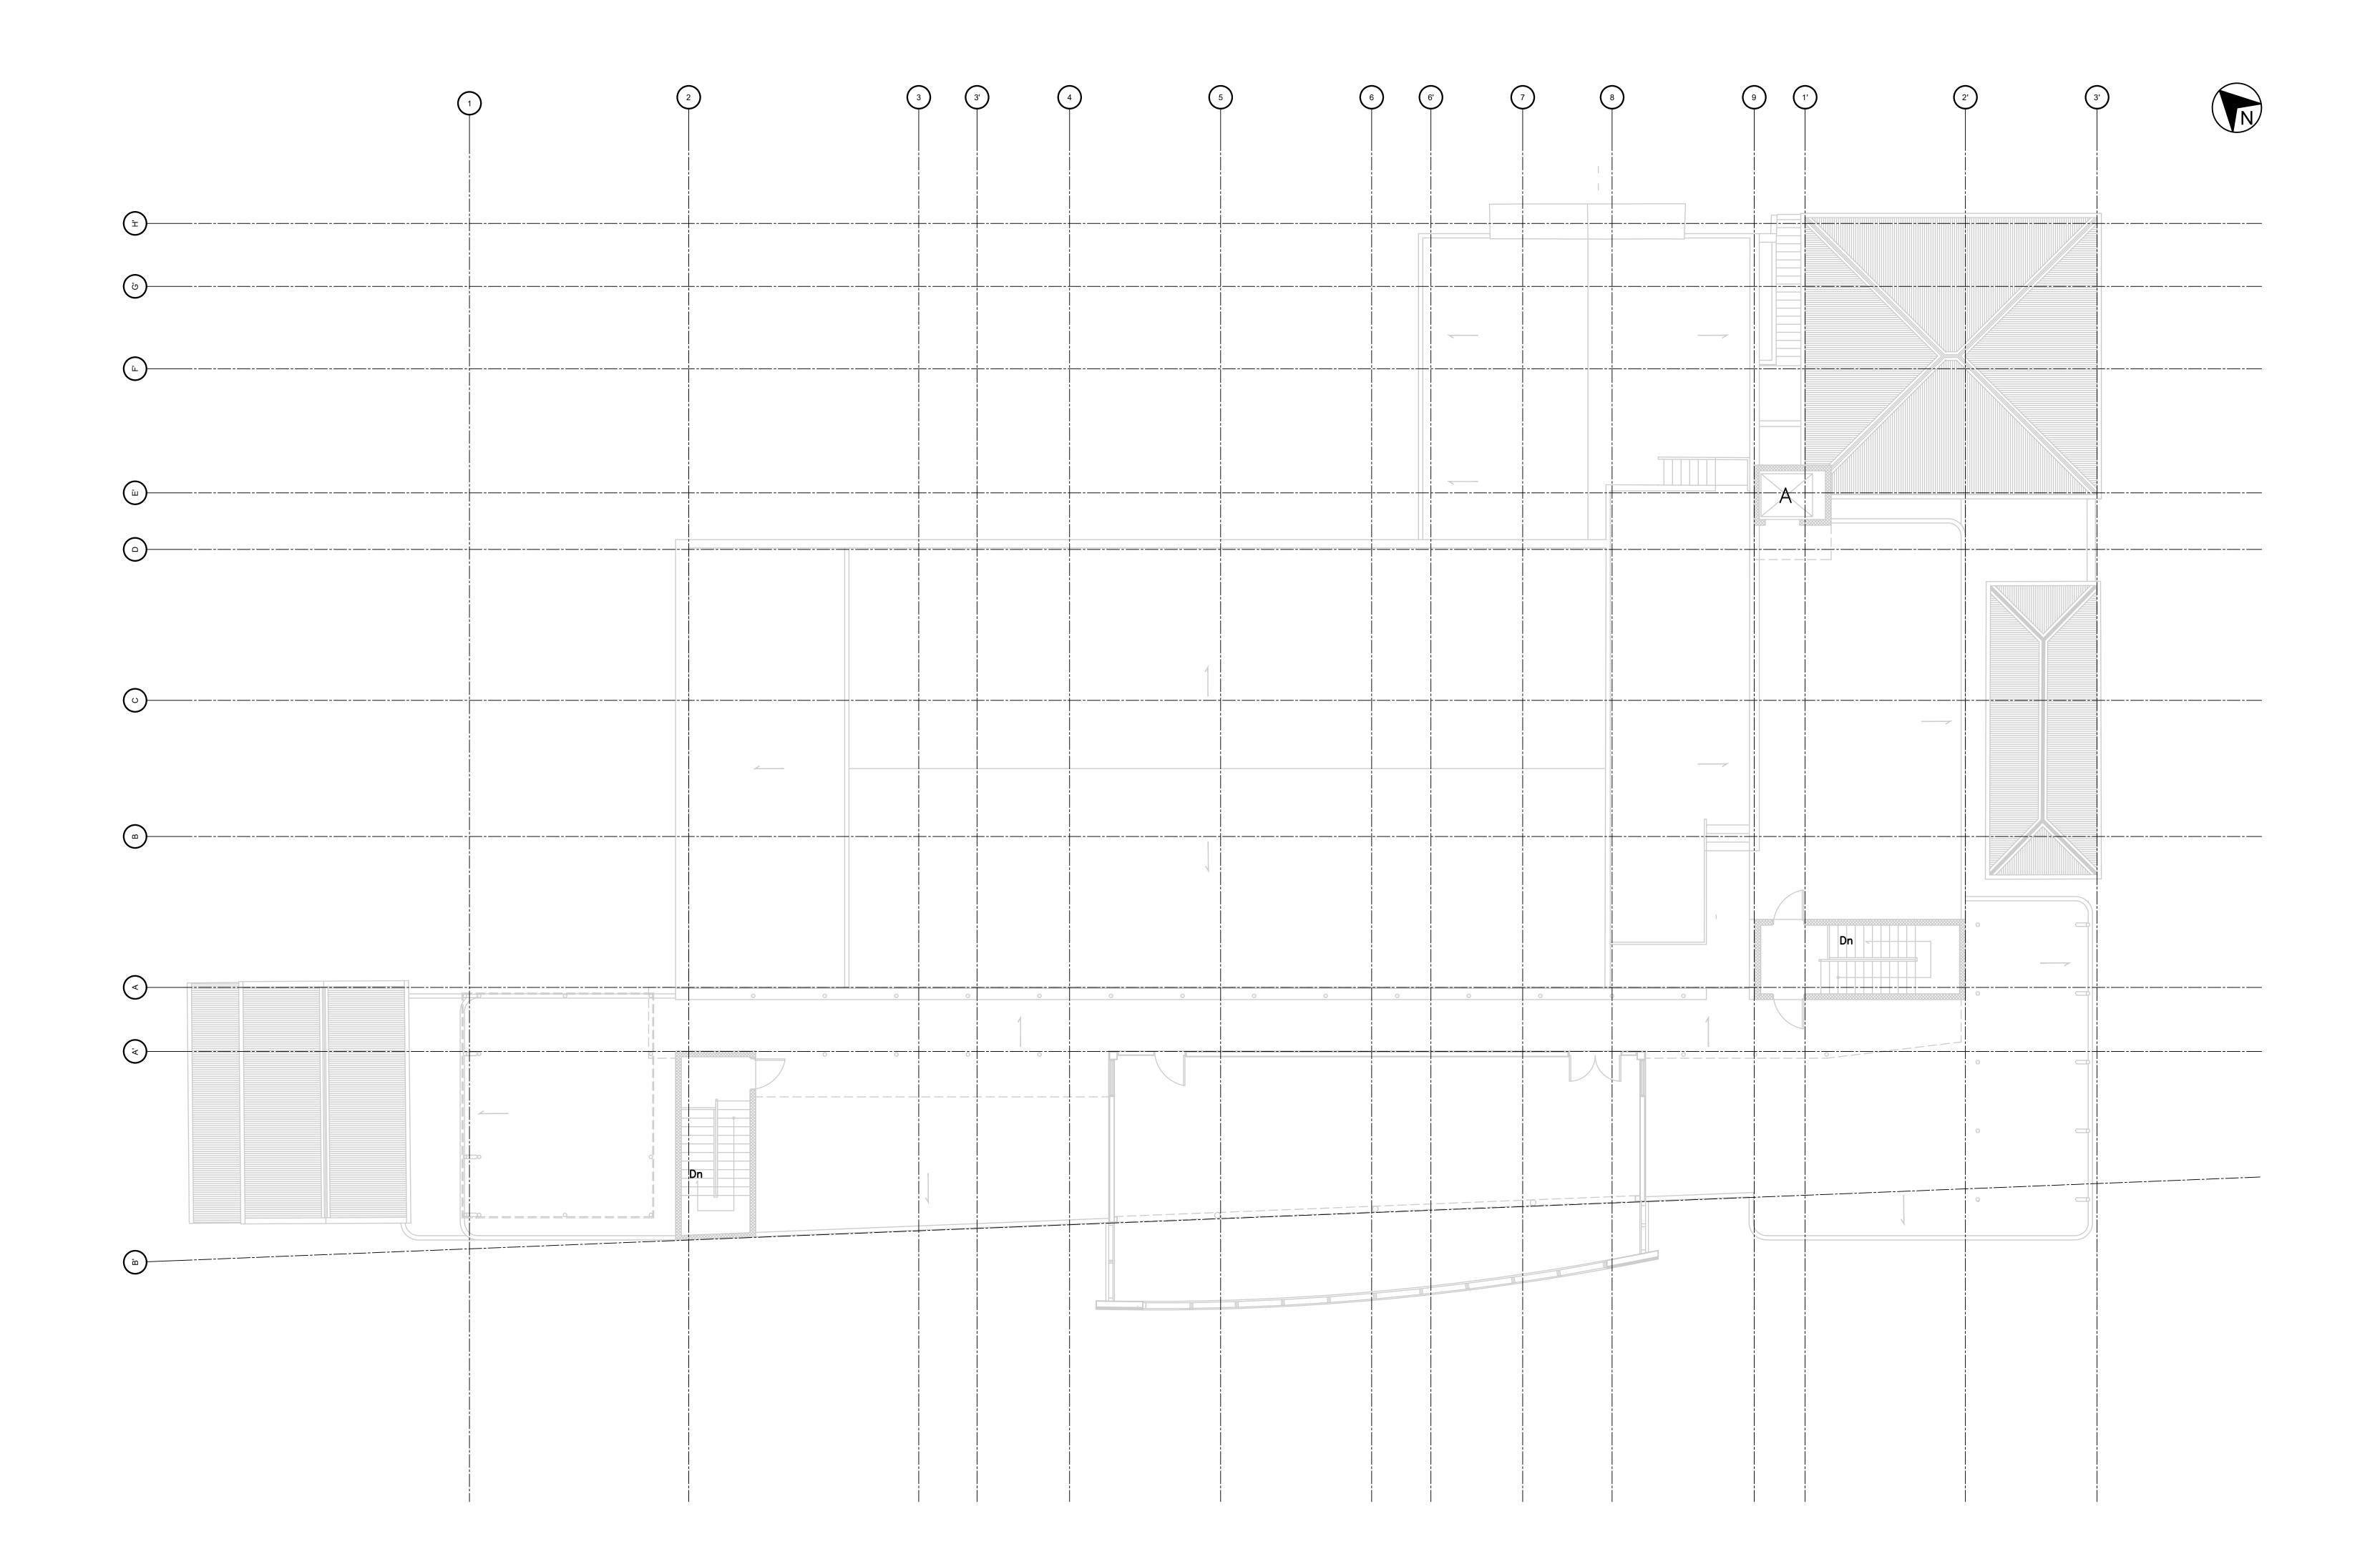
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PLUMBING - SECOND FLOOR PLAN

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PLUMBING - THIRD FLOOR PLAN
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